# Salisbury Historic District Commission AGENDA

# Wednesday, July 26, 2023 at 7:00 pm Government Office Building Room 301

- 1. 7:00 P.M. CALL TO ORDER Scott Saxman, Chairman
- 2. ROLL CALL
- 3. APPROVAL OF MINUTES April 26, 2023, May 24, 2023, & June 28, 2023

PUBLIC INPUT – Members of the public are welcome to make comment at this time, subject to a time allotment of two (2) minutes per person.

- 4. CONSENT DOCKET- None
- 5. OLD BUSINESS None
- 6. NEW BUSINESS
  - #23-16- \*110 E William St- Solar Panels
  - #23-17- 411 Wicomico St- New Construction
  - #23-18- 226 Newton St- Alterations
  - #23-19- 228 Newton St- Alterations

<sup>\*</sup>this indicates that the structure has been deemed a contributing structure by the SHDC

<sup>\*</sup> this indicates that the structure has been deemed a Non-contributing structure by the SHDC

# Salisbury Historic District Commission

# **Hearing Notification**

July 26, 2023

**Hearing Date:** 

| Time:                          | 7:00 pm  |
|--------------------------------|--|
| Location:                      | Government Office Building<br>125 N. Division Street<br>Salisbury, MD. 21804<br>Room 301 |
| Case Number:                   | #23-16   |
| <b>Commission Considering:</b> | Solar Panels   |
| Owner's Name:                  | Lucia Fuentes  |
| Applicant Name:                | Kadiedra Jarrett   |
| Agent/Contractor:              | Not Indicated  |
| Subject Property Address:      | 110 E William St   |
| Historic District:             | Newtown Historic District  |
| Use Category:                  | Residential  |
| Chairman:                      | Mr. Scott Saxman   |
| HDC Staff contact:             | Jessica Budd<br>Associate Planner I<br>(410) 548-3170                                    |

# Salisbury Historic District Commission

125 N. Division Street Room 202 Salisbury, MD 21801 (410) 548-3170/ fax (410) 548-3107

Application Processor (Date)

Permit Application \$50 Fee Received 5/2/23 (date)

Secretary, S.H.D.C. (Date)

| Date Submitted: 5/2/2023   | Case #: 23-16  |
|--|--|
| Date Accepted as Complete: 7/7/23  | Action Required By (45 days): 9/16/23  |
| Subject Location: 110 E William St Salisbury MD 21801  | O N. Lucia Fuentes   |
| Application by: Kadeidra Jarrett   | <ul> <li>Owner Name: <u>Lucia Fuentes</u></li> <li>Owner Address: <u>110 E William St Salisbury MD 2180</u></li> </ul>   |
| Applicant Address: 525 W Baseline Rd Mesa, AZ 85210  | — Owner Address: Owner Phone: (410) 845-0824   |
| Applicant Phone: 980-285-3407  | Owner Email: luciasandoval@hotmail.es  |
|  |  |
|  | structionAddition Other Roof Solar   |
| DemolitionSign <b>DESCRIPTION OF WORK PROPOSED</b> (Please be sp   | Awning Estimated Cost \$46,926.38  |
| material, color, dimensions, etc. must accompany appl<br>method of attachment, position on building, size and fro<br>other signs on building, and a layout of the sign.<br>Rooftop Solar Installation 9.6kW(24 panels)   | lication. If signs are proposed, indicate material,  |
| Are there any easements or deed restrictions for the letter from the easement holder stating their approximately provided by the state of the letter from the easement holder stating their approximately provided by the state of the letter of | val of the proposed work. Yes X No litation Tax Credits? If yes, have you contacted uestions, please provide a copy of your approval   |
| <u>letter from the Maryland Historic 1</u>   |  |
| See Reverse Side for DOCUMENTS REQU All required documents must be submitted to the City Plann least 30 days prior to the next public meeting. Failure to inclapplicant or his/her authorized representative to appear at the application until the next regular scheduled meeting. If an appresubmitted for one year from date of such action. Please be Commission or staff, may visit the subject property prior to the project.  | ner, Department of Infrastructure and Development at<br>lude all the required attachments and/or failure of the<br>the scheduled meeting may result in postponement of the<br>pplication is denied, the same application cannot be<br>be advised that members of the Salisbury Historic District |
| The Salisbury Historic District Commission Rules and Regu<br>the office of the Department of Infrastructure and Developm<br>website: www.ci.salisbury.md.us.   |  |
| I, or my authorized representative, will appear at the meetin on July, 26 2023 (date).   | g of the Salisbury Historic District Commission  |
| I hereby certify that the owner of the subject premises has be that said owner is in full agreement with this proposal.  | peen fully informed of the alterations herein proposed and   |
| Applicant's<br>Signature <u>Kadsidra Garrett</u>   | Date_ 5/2/2023   |
| Jessica Budd 6/8/23  | Brian Soner 6/8/23   |







TO INSTALL A ROOF MOUNTED SOLAR PHOTOVOLTAIC SYSTEM AT THE OWNER RESIDENCE LOCATED AT 110 E. WILLIAM ST., SALISBURY, MD 21801, USA THE POWER GENERATED BY THE PV SYSTEM WILL BE INTERCONNECTED WITH THE UTILITY GRID THROUGH THE EXISTING ELECTRICAL SERVICE EQUIPMENT. THE PV SYSTEM DOES NOT INCLUDE STORAGE BATTERIES

#### **EQUIPMENT SUMMARY**

- HYPERION HY-DH108P8 400W MODULES
- 01 SOLAREDGE SE7600H-US INVERTER
- SOLAREDGE POWER OPTIMIZERS S440 24

# PROJECT DESCRIPTION:

24 X 400 HYPERION HY-DH108P8 400W MODULES ROOF MOUNTED SOLAR PHOTOVOLTAIC MODULES

SYSTEM SIZE:9.60 kW DC STC ARRAY AREA: ROOF#1 - 147.07 SQ FT ARRAY AREA: ROOF#2 - 105.05 SQ FT ARRAY AREA: ROOF#3 - 252.12 SQ FT

**AUTHORITIES HAVING JURISDICTION** BUILDING : SALISBURY CITY : SALISBURY CITY ZONING UTILITY : DELMARVA POWER

## **APPLICABLE CODES & STANDARDS:**

2018 INTERNATIONAL BUILDING CODE 2018 INTERNATIONAL RESIDENTIAL CODE 2018 INTERNATIONAL FIRE CODE 2017 NATIONAL ELECTRICAL CODE

| DESIGN CRITERIA   |              |
|-------------------|--------------|
| WIND SPEED        | 117 MPH VULT |
| RISK CATEGORY     | II           |
| EXPOSURE CATEGORY | С            |
| MOUNTING METHOD   | ROOF MOUNT   |
| GROUND SNOW LOAD  | 20 PSF       |

#### SHEET INDEX

PV-0 **COVER SHEET** PV-1 PLOT PLAN

PV-2 **ROOF PLAN & MODULES** PV-2A STRING LAYOUT

PV-3 ATTACHMENT DETAIL PV-4 to 4A ELECTRICAL LINE DIAGRAM PV-5 WIRING CALCULATIONS

PV-6 to 6A WARNING LABELS & PLACARDS JOB SAFETY PLAN


PV-8 to 14 EQUIPMENT SPECIFICATIONS

#### **GENERAL NOTES:**

- THESE CONSTRUCTION DOCUMENTS HAVE BEEN BASED ON FIELD INSPECTIONS AND OTHER INFORMATION AVAILABLE AT THE TIME. ACTUAL FIELD CONDITIONS MAY REQUIRE MODIFICATIONS IN CONSTRUCTION DETAILS.
- ARCHITECT HAS NOT BEEN RETAINED TO SUPERVISE ANY CONSTRUCTION OR INSTALLATION OF ANY EQUIPMENT AT SITE.
- CONTRACTOR SHALL FURNISH ALL LABOR, MATERIAL, EQUIPMENT, TOOLS, OBTAINS ALL PERMITS, LICENSES AND PAY ALL REQUIRED FEES AND COMPLETE INSTALLATION.
- CONTRACTOR HAS THE FULL RESPONSIBILITY TO CHECK AND VERIFY ALL DIMENSIONS AND EXISTING CONDITIONS. ANY DISCREPANCIES SHALL BE REPORTED TO THE ENGINEER BEFORE PROCEEDING WITH THE WORK. ANY WORK STARTED BEFORE CONSULTATION AND ACCEPTANCE BY THE ENGINEER SHALL BE THE SOLE RESPONSIBILITY OF THE CONTRACTOR AND SHALL BE SUBJECT TO CORRECTION BY THEM WITHOUT ADDITIONAL COMPENSATION.
- DAMAGE CAUSED TO THE EXISTING STRUCTURE, PIPES, DUCTS, WINDOWS, WALL, FLOORS, ETC. SHALL BE REPAIRED TO THE ORIGINAL CONDITION OR REPLACED BY THE CONTRACTOR AT NO ADDITIONAL COST.
- THE CONTRACTOR SHALL BE HELD RESPONSIBLE FOR THE PROPER INSTALLATION AND COMPLETION OF THE WORK WITH APPROVED MATERIALS.
- NO CHANGES ARE TO BE MADE WITHOUT THE CONSULTATION AND APPROVAL OF THE ARCHITECT.
- CONTRACTOR SHALL OBTAIN BUILDING PERMIT. NO WORK TO START UNLESS BUILDING PERMIT IS PROPERLY DISPLAYED.
- ALL WORKMANSHIP AND MATERIALS SHALL BE OF FIRST QUALITY AND IN COMPLIANCE WITH THE REQUIREMENTS OF THE MD BUILDING CODE, THE DEPARTMENT OF ENVIRONMENTAL PROTECTION AND ALL PERTINENT AGENCIES.
- IT IS ESSENTIAL THAT ALL WORK PROCEED WITH THE MAXIMUM COOPERATION OF ALL PARTIES AND WITH MINIMUM INTERFERENCE TO THE OCCUPANTS WITHIN THE BUILDING. THE OWNER'S DIRECTIONS IN THIS REGARD SHALL BE FULLY COMPLIED WITH
- ALL EXPOSED PLUMBING, HVAC, ELECTRICAL DUCTWORK, PIPING AND CONDUITS ARE TO BE PAINTED BY GENERAL CONTRACTOR.
- THE CONTRACTOR SHALL PERFORM THE WORK IN STRICT CONFORMANCE WITH THE LOCAL LAWS, REGULATIONS AND THE NATIONAL ELECTRIC CODE.
- THE CONTRACTOR SHALL OBTAIN ALL PERMITS, APPROVALS, AFFIDAVITS, CERTIFICATIONS, ETC. AND PAY ALL FEES AS REQUIRED BY THE LOCAL AUTHORITIES.
- CONTRACTORS SHALL OBTAIN FIRE CERTIF. UPON COMPLETION OF WORK.

#### **WIRING AND CONDUIT NOTES:**

- ALL CONDUIT SIZES AND TYPES, SHALL BE LISTED FOR ITS PURPOSE AND APPROVED FOR THE SITE APPLICATIONS
- ALL PV CABLES AND HOMERUN WIRES BE #10AWG \*USE-2. PV WIRE, OR PROPRIETARY SOLAR CABLING SPECIFIED BY MFR. OR EQUIVALENT; ROUTED TO SOURCE CIRCUIT COMBINER **BOXES AS REQUIRED**
- ALL CONDUCTORS AND OCPD SIZES AND TYPES SPECIFIED ACCORDING TO [NEC 690.8 (A)(1) & (B)(1)], [NEC 240] [NEC 690.7] FOR MULTIPLE CONDUCTORS
- ALL PV DC CONDUCTORS IN CONDUIT EXPOSED TO SUNLIGHT SHALL BE DERATED ACCORDING TO [NEC TABLE 310.15 (B)(2)(C)] BLACK ONLY\*\*
- EXPOSED ROOF PV DC CONDUCTORS SHALL BE USE-2, 90°C RATED, WET AND UV RESISTANT, AND UL LISTED RATED FOR 600V, UV RATED SPIRAL WRAP SHALL BE USED TO PROTECT WIRE FROM SHARP EDGES
- 4-WIRE DELTA CONNECTED SYSTEMS HAVE THE PHASE WITH THE HIGHER VOLTAGE TO GROUND MARKED ORANGE OR IDENTIFIED BY OTHER EFFECTIVE MEANS
- ALL SOURCE CIRCUITS SHALL HAVE INDIVIDUAL SOURCE CIRCUIT PROTECTION
- **VOLTAGE DROP LIMITED TO 2%**
- AC CONDUCTORS >4AWG COLOR CODED OR MARKED: PHASE A OR L1- BLACK, PHASE B OR L2- RED, PHASE C OR L3- BLUE, **NEUTRAL-WHITE/GRAY**

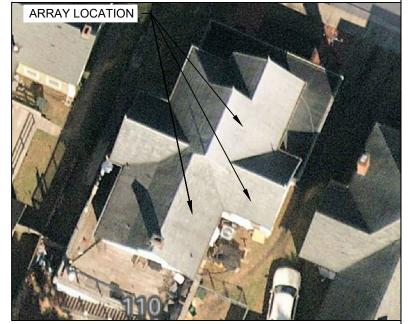





VICINITY MAP PV-0

160 N MCQUEEN RD, GILBERT, AZ 85233, USA

PHONE: (808) 371-5338 TITAN SOLAR POWER

CONTRACTOR LIC# 14480 AND 150562

REVISIONS DESCRIPTION DATE

SIGNATURE WITH SEAL

DATE: 03/23/2023

PROJECT NAME & ADDRESS

110 E. WILLIAM ST., SALISBURY, MD 21801 PH#::(410) 845-0824 LUCIA FUENTE RESIDENCE

SHEET NAME **COVER SHEET** 

SHEET SIZE

**ANSIB** 11" X 17"

SHEET NUMBER

PV-0

SCALE: NTS

#### **ELECTRICAL NOTES:**

- THE EQUIPMENT AND ALL ASSOCIATED WIRING AND INTERCONNECTION SHALL BE INSTALLED ONLY BY QUALIFIED PEOPLE. A QUALIFIED PERSON IS ONE WHO HAS SKILLS AND KNOWLEDGE RELATED TO THE CONSTRUCTION AND OPERATION OF THE ELECTRICAL EQUIPMENT AND INSTALLATIONS AND HAS RECEIVED SAFETY TRAINING TO RECOGNIZE AND AVOID THE HAZARDS INVOLVED. (NEC 690.4(C), NEC 2017)
- LOCAL UTILITY PROVIDER SHALL BE NOTIFIED PRIOR TO USE AND ACTIVATION OF ANY SOLAR PHOTOVOLTAIC INSTALLATION. FOR A LINE SIDE TAP CONNECTION, UTILITY NEEDS TO BE NOTIFIED WELL IN ADVANCE TO COORDINATE BUILDING ELECTRICAL SHUT OFF.
- NEW CONDUIT ROUTING SHOWN IS ESSENTIALLY SCHEMATIC. SUBCONTRACTOR SHALL LAY OUT RUNS TO SUIT FIELD CONDITIONS AND THE COORDINATION REQUIREMENTS OF OTHER TRADES.
- ARRAY WIRING SHOULD NOT BE READILY ACCESSIBLE EXCEPT TO QUALIFIED PERSONNEL.
- ALL EXTERIOR CONDUIT, FITTINGS, AND BOXES SHALL BE WATERTIGHT AND APPROVED FOR USE IN WET LOCATIONS. (NEC 690), NEC 2017.
- WIRING METHODS FOR PV SYSTEM CONDUCTORS AREN'T PERMITTED WITHIN 10 IN. OF THE ROOF DECKING OR SHEATHING EXCEPT WHERE LOCATED DIRECTLY BELOW THE ROOF SURFACE THAT'S COVERED BY PV MODULES AND ASSOCIATED EQUIPMENT WIRING
- BACK-FED BREAKER MUST BE AT THE OPPOSITE END OF BUS BAR FROM THE MAIN BREAKER OR MAIN LUG SUPPLYING CURRENT FROM THE UTILITIES. ALL CONDUCTORS AND WIRE TIES EXPOSED TO SUNLIGHT ARE LISTED AS UV RESISTANT.
- CONTRACTOR SHALL FOLLOW ALL ELECTRICAL EQUIPMENT LABELING REQUIREMENTS IN NEC 690
- PV SOURCE, OUTPUT AND INVERTER CIRCUITS SHALL BE IDENTIFIED AT ALL POINTS OF TERMINATION, CONNECTION, AND SPLICES. THE MEANS OF ID CAN BE SEPARATE COLOR CODING, MARKING TAPE, TAGGING ETC. (NEC 690.4), NEC 2017.
- MEASURE THE LINE-TO-LINE AND LINE-TO-NEUTRAL VOLTAGE OF ALL SERVICE ENTRANCE CONDUCTORS PRIOR TO INSTALLING ANY SOLAR EQUIPMENT. THE VOLTAGES FOR THE 240VAC RATED.

PROPERTYLINE 49'-1" **EQUIPMENT SUMMARY** HYPERION HY-DH108P8 400W MODULES VISIBLE, LABELED, LOCKABLE DISCONNECT LOCATED SOLAREDGE SE7600H-US INVERTER LESS THAN 10' FROM UTILITY METER SOLAREDGE POWER OPTIMIZERS S440 NO ENCROACHMENT INTO EASEMENTS BY NEW SCOPE OF WORK (SOLAR PANELS, RACK/RAIL SYSTEMS & EQUIPMENT). SYSTEM SIZE:9.60 kW DC STC (E) MAIN SERVICE PANEL SYSTEM SIZE:7.60 kW AC STC METER NO: IND357812435 (E) PATHWAY (12) HYPERION HY-DH108P8 400W MODULES 2-STORY HOUSE - 36" FIRE SETBACK (05) HYPERION HY-DH108P8 400W MODULES (07) HYPERION HY-DH108P8 400W MODULES 15'-0" (E) POOL TREES (E) FENCE 49'-6" PROPERTY LINE PLOT PLAN (E) DETACHED STRUCTURE PV-1 SCALE: 1/16" = 1'-0"



TITAN SOLAR POWER

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TITAN SOLAR POWER

CONTRACTOR LIC# 14480 AND 150562

| REVISIONS   |      |     |
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| DESCRIPTION | DATE | REV |
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SIGNATURE WITH SEAL

DATE: 03/23/2023

PROJECT NAME & ADDRESS

LUCIA FUENTES RESIDENCE

HEET NAME


110 E. WILLIAM ST., SALISBURY, MD 21801 PH#.:(410) 845-0824

PLOT PLAN

SHEET SIZE

ANSI B 11" X 17"

SHEET NUMBER

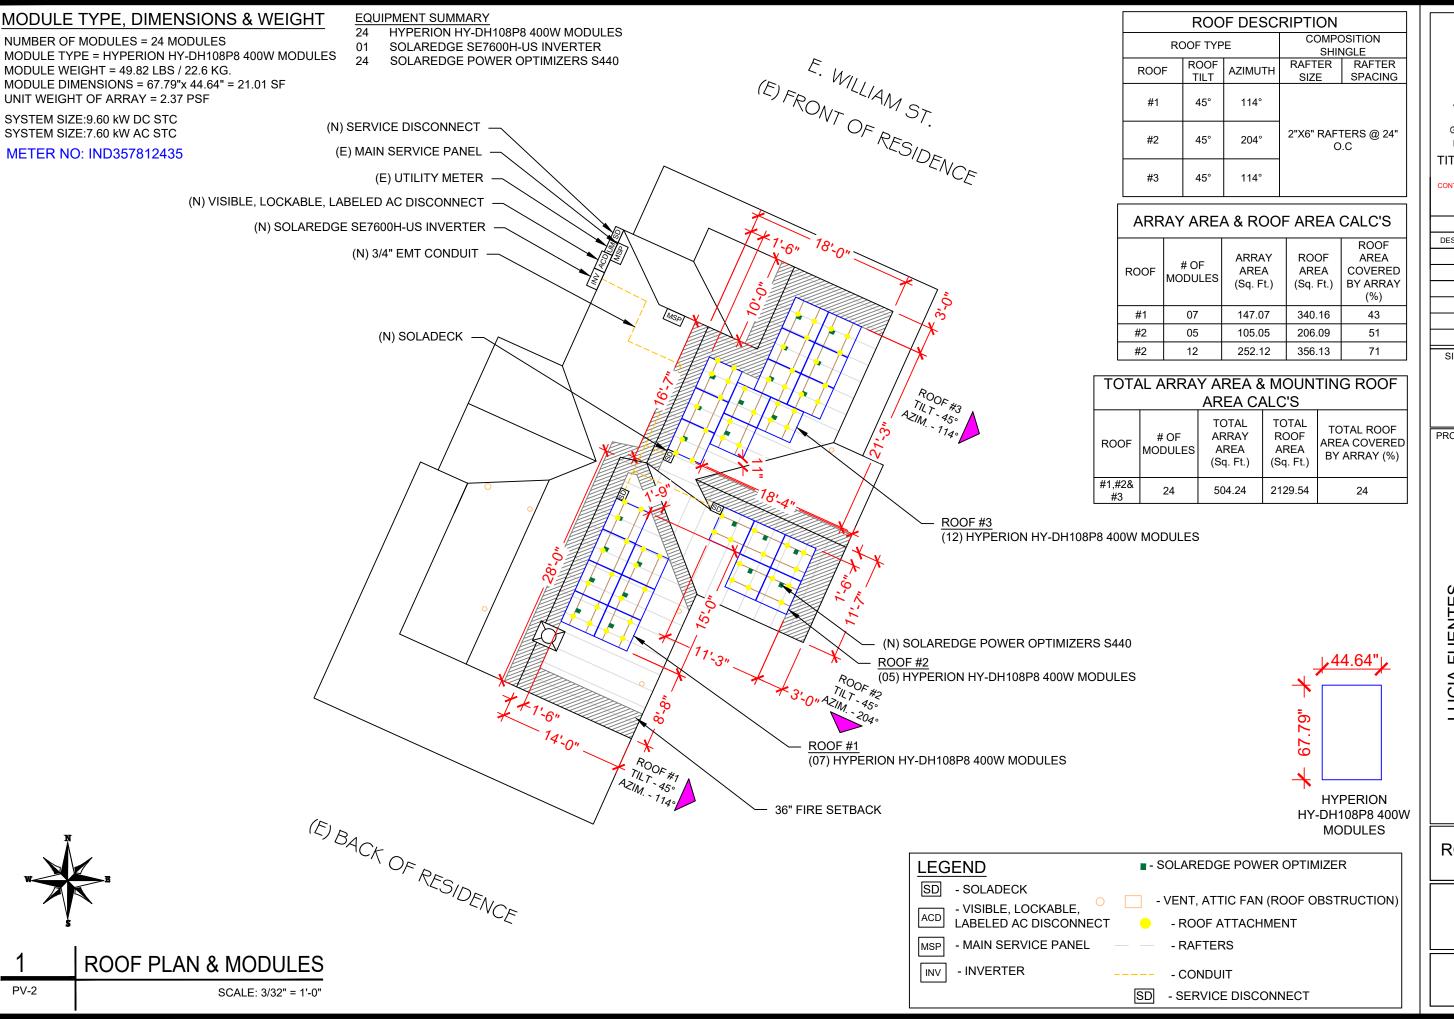



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LUCIA FUENTES RESIDENCE


SHEET NAME

ROOF PLAN & MODULES

SHEET SIZE

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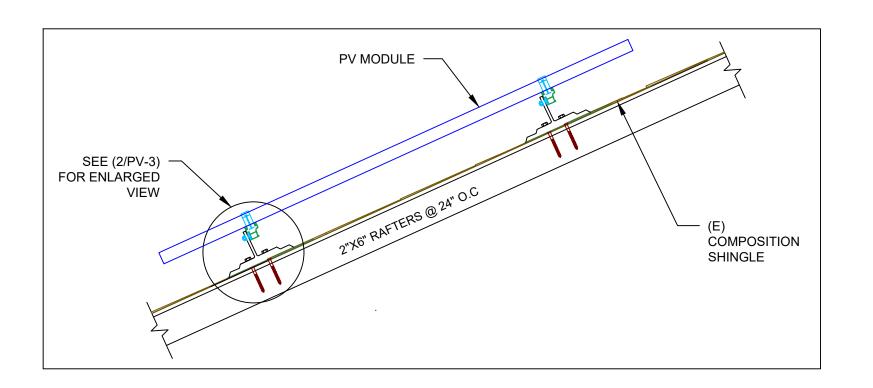
SHEET NAME
STRING
LAYOUT

SHEET SIZE

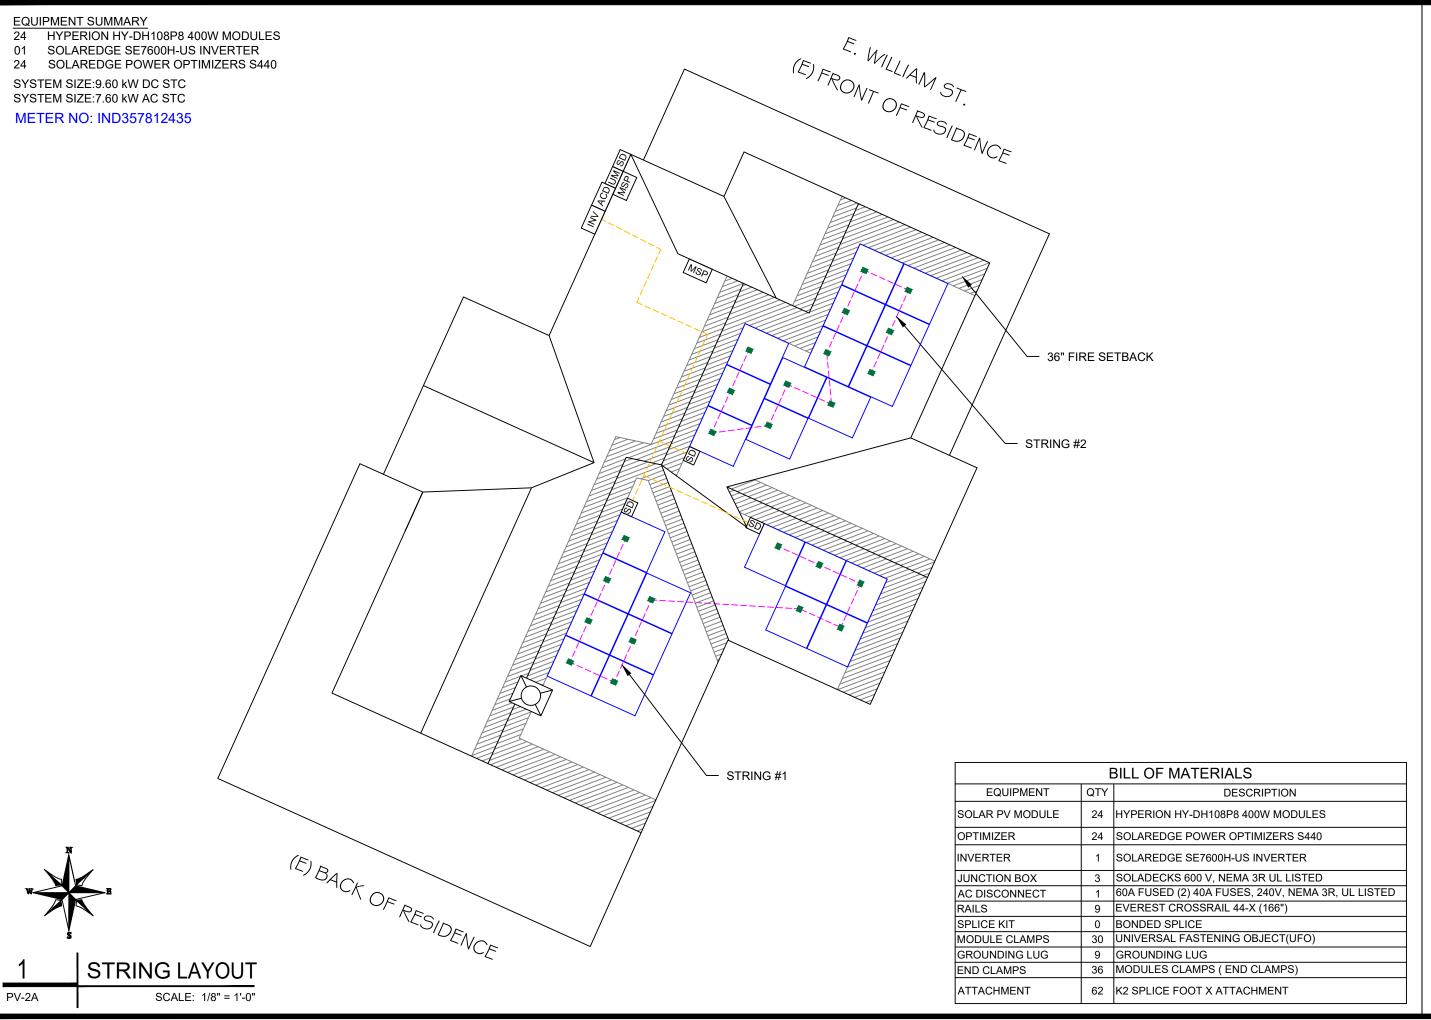ANSI B 11" X 17"

SHEET NUMBER

PV-2A



1 ATTACHMENT DETAIL

SCALE: NTS

FLASHING W/SEALANT
2"X6" RAFTERS @ 24" O.C

ATTACHMENT DETAIL (enlarged view)

END/MID CLAMP
T-BOLT
PV MODULES

K2 CROSSRAIL 44-X (166")

COMPOSITION SHINGLE



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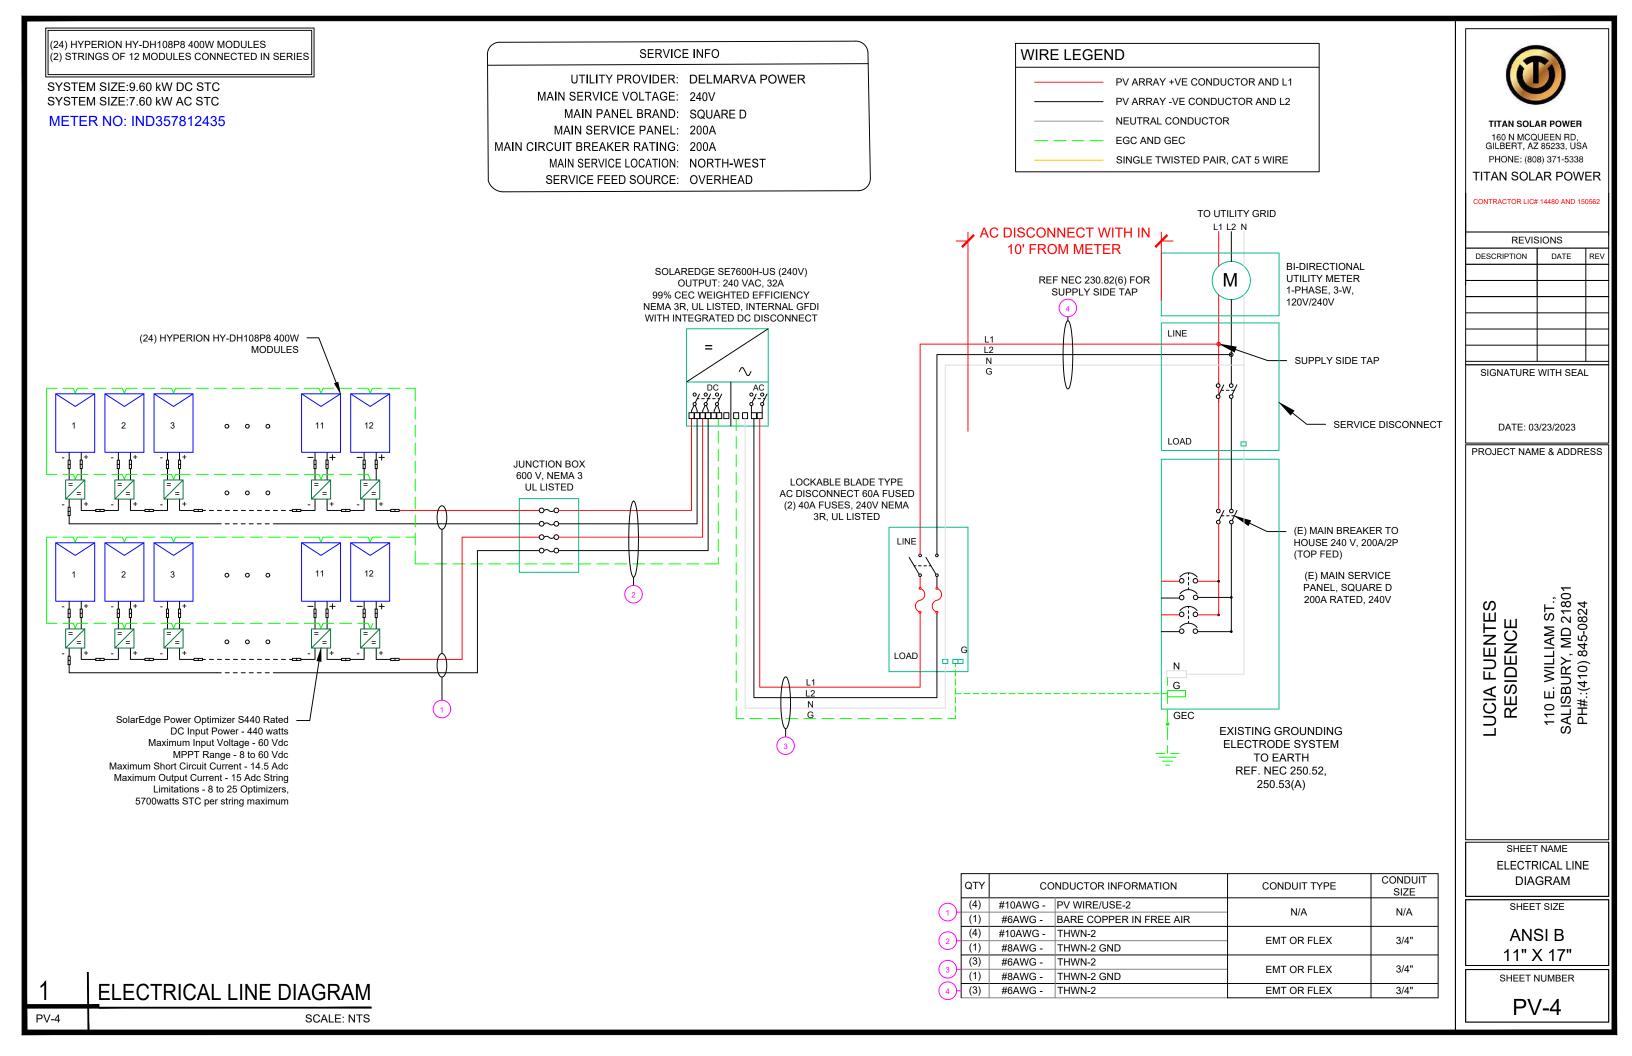
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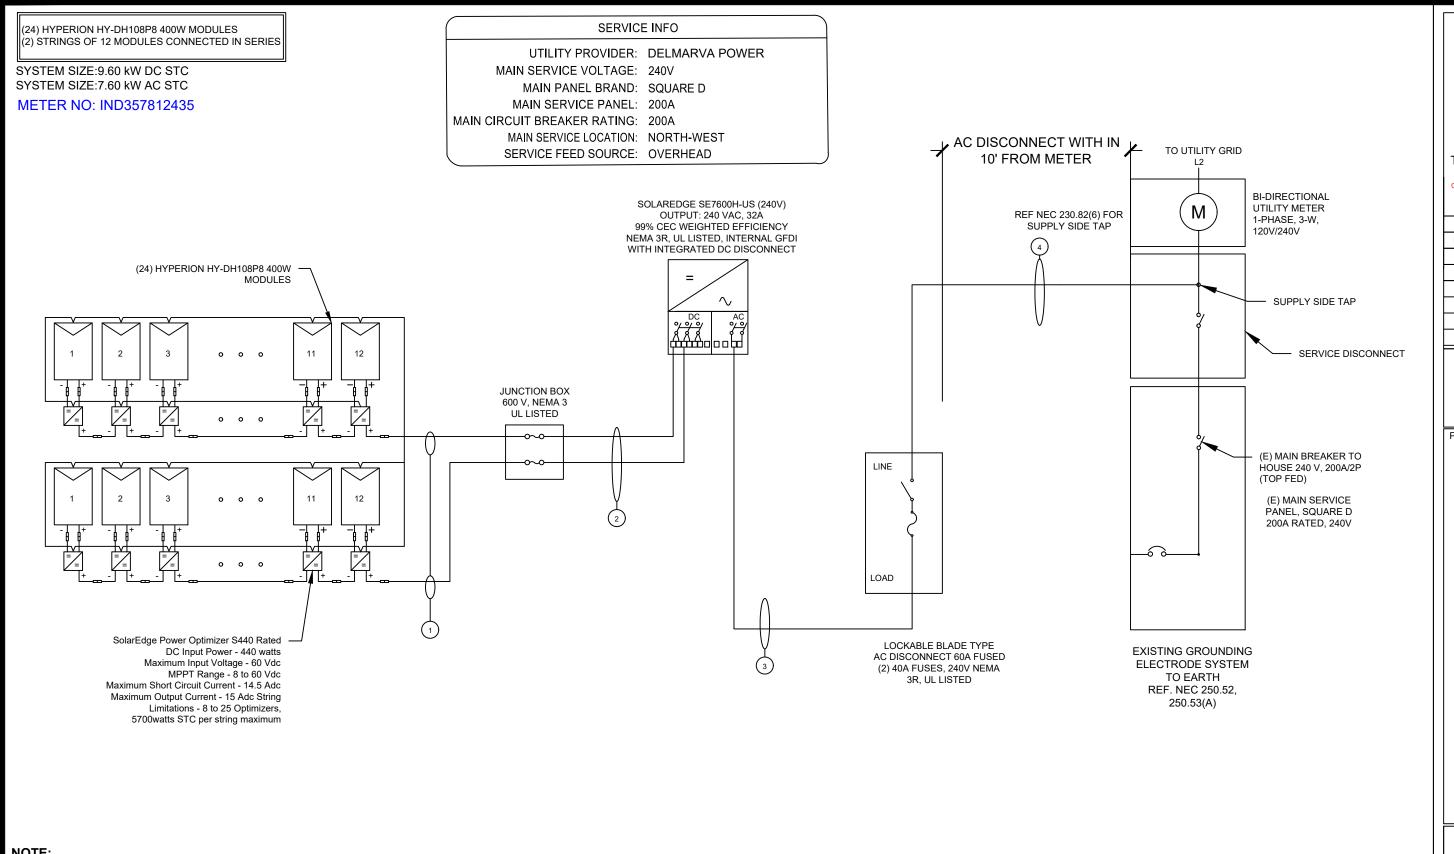
ATTACHMENT DETAIL

SHEET SIZE

ANSI B 11" X 17"

SHEET NUMBER





## NOTE:

- VISIBLE LOCKABLE LABELED AC DISCONNECT TO BE PLACED WITHIN 10' OF UTILITY METER.
- MEETS UL2703 SYSTEM EQUIPMENT GROUNDING AND BONDING STANDARD.
- INVERTER(S) EQUIPPED WITH RAPID SHUTDOWN PER NEC 690.12.

| 1     | ONE LINE DIAGRAM |
|-------|------------------|
| PV-4A | SCALE: NTS       |

|               | QTY | CC       | NDUCTOR INFORMATION     | CONDUIT TYPE  | SIZE |
|---------------|-----|----------|-------------------------|---------------|------|
|               | (4) | #10AWG - | PV WIRE/USE-2           | N/A           | N/A  |
| $\overline{}$ | (1) | #6AWG -  | BARE COPPER IN FREE AIR | IN/A          | IN/A |
| (2)-          | (4) | #10AWG - | THWN-2                  | EMT OR FLEX   | 3/4" |
| 4             | (1) | #8AWG -  | THWN-2 GND              | EWI OR FLEX   | 3/4  |
| (3)-          | (3) | #6AWG -  | THWN-2                  | EMT OR FLEX   | 3/4" |
| $\mathcal{C}$ | (1) | #8AWG -  | THWN-2 GND              | EIVIT OR FLEX | 3/4  |
| (4)           | (3) | #6AWG -  | THWN-2                  | EMT OR FLEX   | 3/4" |



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## TITAN SOLAR POWER

CONTRACTOR LIC# 14480 AND 150562

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RESIDENCE
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SALISBURY, MD 21801
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SHEET NAME ONE LINE DIAGRAM

SHEET SIZE

ANSI B 11" X 17"

SHEET NUMBER

PV-4A

| SOLAR MODULE SPECIFICATIONS |                                      |
|-----------------------------|--------------------------------------|
| MANUFACTURER / MODEL #      | HYPERION HY-DH108P8 400W             |
| VMP                         | 31.01V                               |
| IMP                         | 12.90A                               |
| VOC                         | 37.07V                               |
| ISC                         | 13.79A                               |
| TEMP. COEFF. VOC            | -0.304%/°C                           |
| PTC RATING                  | 371.7W                               |
| MODULE DIMENSION            | 67.97"L x 44.64"W x 1.37"D (In Inch) |

| INVERTER #1 SPECIFICATIONS |                      |
|----------------------------|----------------------|
| MANUFACTURER / MODEL #     | SOLAREDGE SE7600H-US |
| NOMINAL AC POWER           | 7.6 KW               |
| NOMINAL OUTPUT VOLTAGE     | 240 VAC              |
| NOMINAL OUTPUT CURRENT     | 32.0 A               |

| POWER OPTIMIZER (OPTIMIZER S440-2NM4ARS) |          |
|--|----------|
| MAXIMUM INPUT POWER                      | 440W     |
| MINIMUM INPUT VOLTAGE                    | 8 VDC    |
| MAXIMUM INPUT VOLTAGE                    | 60VDC    |
| MAXIMUM MODULE ISC                       | 14.5 ADC |
| MAXIMUM OUTPUT CURRENT                   | 15 ADC   |

| PERCENT OF VALUES | NUMBER OF CURRENT<br>CARRYING CONDUCTORS IN EMT |
|-------------------|---|
| 0.80              | 4-6   |
| 0.70              | 7-9   |
| 0.50              | 10-20   |

| AMBIENT TEMPERATURE SPECS             |            |  |  |
|---------------------------------------|------------|--|--|
| RECORD LOW TEMP                       | -10°       |  |  |
| AMBIENT TEMP (HIGH TEMP 2%)           | 34°        |  |  |
| CONDUIT HEIGHT                        | 0.5"       |  |  |
| ROOF TOP TEMP                         | 90°        |  |  |
| CONDUCTOR TEMPERATURE RATE            | 56°        |  |  |
| MODULE TEMPERATURE COEFFICIENT OF Voc | -0.304%/°C |  |  |

| DC CONDUCTOR AMPACITY CALCULAT  | TONS: |  |  |
|---|-------|--|--|
| ARRAY TO JUNCTION BOX:  |       |  |  |
| EXPECTED WIRE TEMP (In Celsius)   | 34°   |  |  |
| TEMP. CORRECTION PER TABLE (310.16)   | 0.96  |  |  |
| NO. OF CURRENT CARRYING CONDUCTORS  | 4     |  |  |
| CONDUIT FILL CORRECTION PER NEC 310.15(B)(2)(a)   | 0.80  |  |  |
| CIRCUIT CONDUCTOR SIZE (AWG)  | 10    |  |  |
| CIRCUIT CONDUCTOR AMPACITY (A)  | 40    |  |  |
|   |       |  |  |
| REQUIRED CIRCUIT CONDUCTOR AMPACITY PER NEC 690.8(A&B) 1.25 X Isc (A)                                   | 18.75 |  |  |
| DERATED AMPACITY OF CIRCUIT CONDUCTOR PER NEC TABLE 310.16  |       |  |  |
| CONDUIT FILL CORRECTION PER NEC 310.15(B)(2)(a) X CIRCUIT CONDUCTOR AMPACITY (A)                        | 30.72 |  |  |
| Result should be greater than (18.75A) otherwise less the entry for circuit conductor size and ampacity |       |  |  |

| DC CONDUCTOR AMPACITY CALCUI  | _ATIONS:                |
|---|-------------------------|
| FROM JUNCTION BOX TO INVER  | TER:                    |
| AMBIENT TEMPERATURE ADJUSTMENT FOR EXPOSED CONDUIT, PER NEC 310.15(B)(2)(c)       | 22°                     |
| EXPECTED WIRE TEMP (In Celsius)   | 34°+22° = 56°           |
| TEMP. CORRECTION PER TABLE (310.16)   | 0.71                    |
| NO. OF CURRENT CARRYING CONDUCTORS  | 4                       |
| CONDUIT FILL CORRECTION PER NEC 310.15(B)(2)(a)                                   | 0.80                    |
| CIRCUIT CONDUCTOR SIZE (AWG)  | 10                      |
| CIRCUIT CONDUCTOR AMPACITY (A)  | 40                      |
| REQUIRED CIRCUIT CONDUCTOR AMPACITY PER NEC 690.8(A&B) 1.25 X lsc (A)             | 18.75                   |
| DERATED AMPACITY OF CIRCUIT CONDUCTOR PER NEC TABLE 310.16                        |                         |
| CONDUIT FILL CORRECTION PER NEC 310.15(B)(2)(a) X CIRCUIT CONDUCTOR AMPACITY (A)  | 22.72                   |
| Result should be greater than (18.75A) otherwise less the entry for circuit condu | ictor size and ampacity |

- 1.) ALL EQUIPMENT TO BE LISTED BY UL OR OTHER NRTL, AND LABELED FOR ITS APPLICATION.
- 2.) ALL CONDUCTORS SHALL BE COPPER, RATED FOR 600 V AND 90 DEGREE C WET ENVIRONMENT.
- 3.) WIRING, CONDUIT, AND RACEWAYS MOUNTED ON ROOFTOPS SHALL BE ROUTED DIRECTLY TO, AND LOCATED AS CLOSE AS POSSIBLE TO THE NEAREST RIDGE, HIP, OR VALLEY.
- 4.) WORKING CLEARANCES AROUND ALL NEW AND EXISTING ELECTRICAL EQUIPMENT SHALL COMPLY WITH NEC 110.26.
- 5.) DRAWINGS INDICATE THE GENERAL ARRANGEMENT OF SYSTEMS. CONTRACTOR SHALL FURNISH ALL NECESSARY OUTLETS, SUPPORTS, FITTINGS AND ACESSORIES TO FULFILL APPLICABLE CODES AND STANDARDS.
- 6.) WHERE SIZES OF SOLADECK, RACEWAYS, AND CONDUITS ARE NOT SPECIFIED, THE CONTRACTOR SHALL SIZE THEM ACCORDINGLY.
- 7.) ALL WIRE TERMINATIONS SHALL BE APPROPRIATELY LABELED AND READILY VISIBLE.
- 8.) MODULE GROUNDING CLIPS TO BE INSTALLED BETWEEN MODULE FRAME AND MODULE SUPPORT RAIL, PER THE GROUNDING CLIP MANUFACTURER'S INSTRUCTION.
- 9.) MODULE SUPPORT RAIL TO BE BONDED TO CONTINUOUS COPPER G.E.C. VIA WEEB LUG OR ILSCO GBL-4DBT LAY-IN LUG.
- 10.) THE POLARITY OF THE GROUNDED CONDUCTORS IS NEGATIVE

| AC CONDUCTOR AMPACITY CALCULAT   | 10113.       |
|--|--------------|
| No. OF INVERTER  | 1            |
| EXPECTED WIRE TEMP (In Celsius)  | 34°          |
| TEMP. CORRECTION PER TABLE (310.16)  | 0.94         |
| NO. OF CURRENT CARRYING CONDUCTORS   | 3            |
| CONDUIT FILL CORRECTION PER NEC 310.15(B)(2)(a)  | 1            |
| CIRCUIT CONDUCTOR SIZE (AWG)   | 6AWG         |
| CIRCUIT CONDUCTOR AMPACITY (A)   | 65           |
|  |              |
| REQUIRED CIRCUIT CONDUCTOR AMPACITY PER NEC 690.8(A&B) 1.25 X Isc (A)  | 40           |
| DERATED AMPACITY OF CIRCUIT CONDUCTOR PER NEC TABLE 310.16   |              |
| TEMP. CORRECTION PER TABLE (310.16) X CONDUIT FILL CORRECTION PER NEC 310.15(B)(2)(a) X CIRCUIT CONDUCTOR AMPACITY (A) | 61.10        |
| Result should be greater than (40.00A) otherwise less the entry for circuit c<br>and ampacity                          | onductor siz |



#### TITAN SOLAR POWE

160 N MCQUEEN RD, GILBERT, AZ 85233, USA PHONE: (808) 371-5338

# PHONE: (808) 371-5338 TITAN SOLAR POWER

CONTRACTOR LIC# 14480 AND 150562

| REVISIONS   |      |     |  |  |
|-------------|------|-----|--|--|
| DESCRIPTION | DATE | REV |  |  |
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SIGNATURE WITH SEAL

DATE: 03/23/2023

PROJECT NAME & ADDRESS

LUCIA FUENTES RESIDENCE

> SHEET NAME WIRING

110 E. WILLIAM ST., SALISBURY, MD 21801 PH#.:(410) 845-0824

CALCULATIONS


SHEET SIZE

ANSI B 11" X 17"

SHEET NUMBER



- · RED BACKGROUND
- · WHITE LETTERING
- · MINIMUM 3/8" LETTER HEIGHT
- · ALL CAPITAL LETTERS
- · ARIAL OR SIMILAR FONT
- · REFLECTIVE WEATHER RESISTANT MATERIAL, UL969

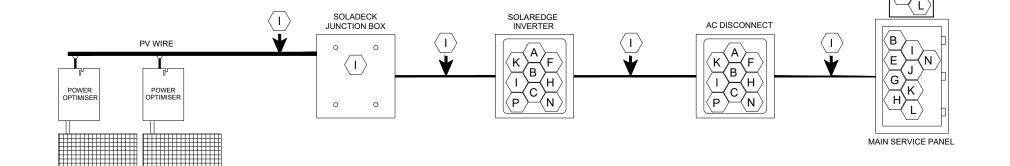

# **A WARNING**

## **ELECTRIC SHOCK HAZARD**

TERMINALS ON THE LINE AND LOAD SIDES MAY BE **ENERGIZED IN THE OPEN POSITION** 

## LABEL LOCATION:

AC & DC DISCONNECT AND SUB PANEL (PER CODE: NEC 690.17(E)

# **WARNING**

#### **ELECTRIC SHOCK HAZARD**

TERMINALS ON BOTH LINE AND LOAD SIDES MAY BE ENERGIZED IN THE OPEN POSITION

DC VOLTAGE IS ALWAYS PRESENT WHEN SOLAR MODULES ARE **EXPOSED TO SUNLIGHT** 

## LABEL LOCATION: DC DISCONNECT, POINT OF INTERCONNECTION (PER CODE: NEC 690.17(E)

# **WARNING**

# **ELECTRIC SHOCK HAZARD**

IF GROUND FAULT IS INDICATED ALL NORMALLY GROUNDED **CONDUCTORS MAY BE UNGROUNDED AND ENERGIZED** 

# LABEL LOCATION:

NEC 690.54

AC & DC DISCONNECT AND SUB PANEL (PER CODE: NEC 690.5(C)

PHOTOVOLTIC AC DISCONNECT RATED AC OUTPUT CURRENT: 32A NOMINAL OPERATING AC VOLTAGE: 240V



LABEL LOCATION: **RAPID SHUTDOWN** (PER CODE: NEC 690.56(C)(3)

# WARNING DUAL POWER SOURCE SECOND SOURCE IS PHOTOVOLTAIC **SYSTEM**

**SOLAR ARRAY** 

 $\langle F \rangle$ 

 $\langle \mathsf{G} \rangle$ 

#### LABEL LOCATION:

 $\langle A \rangle$ 

 $\langle \mathsf{B} \rangle$ 

MAIN SERVICE PANEL & NET METER (PER CODE: NEC 705.12(G)(3), NEC 705.12(B)(3-4) & NEC 690.59)

# WARNING

THE DISCONNECTION OF THE GROUNDED CONDUCTOR(S) MAY RESULT IN OVERVOLTAGE ON THE EQUIPMENT

# LABEL LOCATION:

**INVERTER** 

(PER CODE: NEC 690.31(I)

PHOTOVOLTAIC SYSTEM CIRCUIT IS BACKFED

## LABEL LOCATION: MSP

(PER CODE: NEC 690.13 (F), NEC 705.12(B)(3-4) & NEC 690.59)

PHOTOVOLTAIC POWER SOURCE

(PER CODE: NEC690.31(D)(2)

# **▲ WARNING**

POWER SOURCE OUTPUT CONNECTION DO NOT RELOCATE THIS **OVERCURRENT DEVICE** 


## LABEL LOCATION:

SERVICE PANEL IF SUM OF BREAKERS EXCEEDS PANEL RATING

# (PER CODE: NEC 705.12 (B)(2)(b)

# **SOLAR PV SYSTEM EQUIPPED** WITH RAPID SHUTDOWN

**TURN RAPID** SHUTDOWN SWITCH TO THE "OFF" POSITION TO SHUTDOWN PV SYSTEM AND REDUCE SHOCK HAZARD IN ARRAY

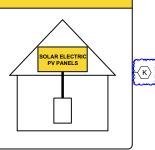

LABEL LOCATION: AC DISCONNECT, DC DISCONNECT, POINT OF INTERCONNECTION (PER CODE: 605.11.3.1(1) & 690.56(C)(1)(a))

# **MAIN PHOTOVOLTAIC SYSTEM DISCONNECT**

LABEL LOCATION: MAIN SERVICE DISCONNECT / **UTILITY METER** (PER CODE: NEC 690.13(B))

#### **INVERTER**

480V  $\langle P \rangle$ 

20A 30A

LABEL LOCATION:

PV DC DISCONNECT NEC 690.53 (ON INVERTER)

# **PHOTOVOLTAIC**

 $\langle M \rangle$ 

# AC DISCONNECT

LABEL LOCATION: **AC DISCONNECT** NEC 690.13(B)



TITAN SOLAR POWER 160 N MCQUEEN RD, GILBERT, AZ 85233, USA

# PHONE: (808) 371-5338 TITAN SOLAR POWER

CONTRACTOR LIC# 14480 AND 150562

| REVISIONS   |      |     |  |  |
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| DESCRIPTION | DATE | REV |  |  |
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SIGNATURE WITH SEAL

DATE: 03/23/2023

PROJECT NAME & ADDRESS

FUENTES LUCIA FUENTE RESIDENCE

SHEET NAME

110 E. WILLIAM ST., SALISBURY, MD 21801 PH#.:(410) 845-0824

LABELS

SHEET SIZE


**ANSIB** 11" X 17"

SHEET NUMBER


# CAUTION: MULTIPLE SOURCES OF POWER

POWER TO THIS BUILDING IS ALSO SUPPLIED FROM THE FOLLOWING SOURCES WITH DISCONNECTS LOCATED AS SHOWN

MAIN SERVICE PANEL & UTILITY METER AC DISCONNECT INVERTER

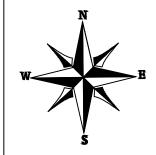

110 E. WILLIAM ST., SALISBURY, MD 21801

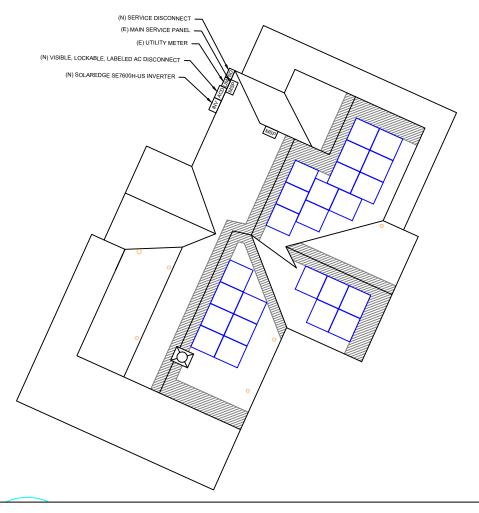

PER CODE(S): NEC 2017: 705.10 + 710.10



TITAN SOLAR POWER

160 N MCQUEEN RD,
GILBERT, AZ 85233, USA

PHONE: (808) 371-5338
TITAN SOLAR POWER

CONTRACTOR LIC# 14480 AND 150562

| REVISIONS   |      |     |  |  |
|-------------|------|-----|--|--|
| DESCRIPTION | DATE | REV |  |  |
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DATE: 03/23/2023

PROJECT NAME & ADDRESS

JCIA FUENTES RESIDENCE

SHEET NAME

PLACARDS


SHEET SIZE

ANSI B 11" X 17"

SHEET NUMBER

PV-6A

# JOB SAFETY PLAN

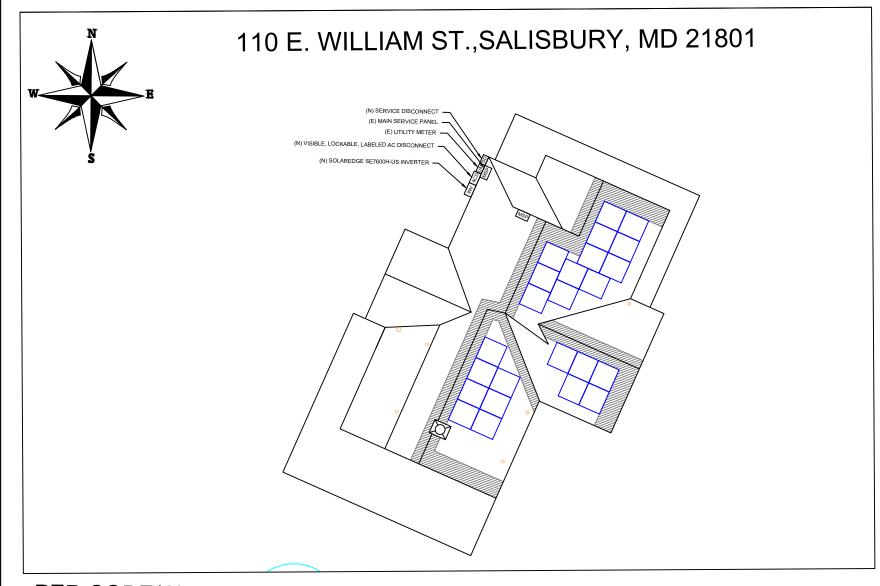

PER CODE(S): NEC 2017: 705.10 + 710.10

LOCATION OF NEAREST URGENT CARE FACILITY

NAME:

ADDRESS:

PHONE NUMBER:

# NOTES:

- · INSTALLER SHALL DRAW IN DESIGNATED SAFETY AREA AROUND HOME
- · INSTALLER SHALL UPDATE NAME, ADDRESS, AND PHONE NUMBER OF NEAREST URGENT CARE FACILITY RELATIVE TO THE JOB SITE BEFORE STARTING WORK.

| PRINT NAME | INITIAL | YES | NO |
|------------|---------|-----|----|
|            |         |     |    |
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|            |         |     |    |



160 N MCQUEEN RD, GILBERT, AZ 85233, USA

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CONTRACTOR LIC# 14480 AND 150562

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DATE: 03/23/2023

PROJECT NAME & ADDRESS

ICIA FUENTES RESIDENCE

110 E. WILLIAM ST. SALISBURY, MD 218

SHEET NAME

SAFETY PLAN

SHEET SIZE

ANSI B 11" X 17"

SHEET NUMBER



390-410W

HY-DH108P8 108 HALF-CELL BIFACIAL MODUL

Module efficiency up to 21.0% achieved through advanced cell technology and manufacturing process

High conversion efficiency




#### Excellent weak light performance



More power output in weak light condition, such as cloudy, morning and sunset



## Extended mechanical performance

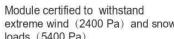




High module quality ensures long-term reliability

Producer Address: Amata City Industrial Estate,

Mapyangphon Subdistrict, Pluak Daeng District,

info@hyperion-usa.com

Rayong Province, Thailand

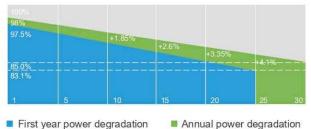

First year power degradation

and processing

warranty for materials

warranty for extra





linear power output



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| NMOT                            |        |        |        |        |        |  |
|---------------------------------|--------|--------|--------|--------|--------|--|
| Maximum Power at NMOT (Pmax)    | 309.4W | 305.8W | 302.2W | 298.5W | 294.8W |  |
| Optimum Operating Voltage (Vmp) | 29.2V  | 29.0V  | 28.8V  | 28.6V  | 28.4V  |  |
| Optimum Operating Current (Imp) | 10.67A | 10.63A | 10.58A | 10.53A | 10.47A |  |
| Open Circuit Voltage (Voc)      | 35.21V | 35.00V | 34.77V | 34.61V | 34.43V |  |
| Short Circuit Current (Isc)     | 11.22A | 11.18A | 11.13A | 11.08A | 11.02A |  |

405W

31.21V

12.98A

13.87A

20.7%

Irradiance 800 W/m<sup>2</sup>, ambient temperature 20 °C, AM=1.5, wind speed 1 m/s.

## Electrical Characteristics with Different Rearside Power Gain (Reference to 405W Front)

410W

31.45V

13.04A

37.32V

13.95A

21.0%

-40 °C to +85 °C

1500 V DC (IEC)

| Rearside Power Gain             | 5%     | 15%    | 25%    |
|---------------------------------|--------|--------|--------|
| Maximum Power at STC (Pmax)     | 425W   | 466W   | 506W   |
| Optimum Operating Voltage (Vmp) | 31.41V | 31.41V | 31.40V |
| Optimum Operating Current (Imp) | 13.59A | 14.88A | 16.18A |
| Open Circuit Voltage (Voc)      | 37.22V | 37.23V | 37.23V |
| Short Circuit Current (Isc)     | 14.48A | 15.86A | 17.24A |
| Module Efficiency               | 21.68% | 23.74% | 25.81% |
|                                 |        |        |        |

#### Temperature Characteristics

**Electrical Characteristics** Maximum Power at STC (Pmax)

Optimum Operating Voltage (Vmp)

Optimum Operating Current (Imp)

Open Circuit Voltage (Voc)

Short Circuit Current (Isc)

Maximum System Voltage

Operating Module Temperature

Module Efficiency

| remperature characteristics                 |            |
|---|------------|
| Nominal Module Operating Temperature (NMOT) | 42 ± 2 °C  |
| Nominal Cell Operating Temperature          | 45 ± 2 °C  |
| Temperature Coefficient of Pmax             | -0.36%/°C  |
| Temperature Coefficient of Voc              | -0.304%/°C |
| Temperature Coefficient of Isc              | 0.050%/°C  |
|   |            |

Current-Voltage & Power-Voltage Curve (410S) 1000 W/m- 800 W/m- 600 W/m- 400 W/m 200 W/m-

HY-DH108P8 390-410W(B)

Solar Cell

No. of Cells Dimensions

Junction Box

Output Cables

Container

Bifaciality

Fire Resistance

Front/Back Glass

Max. System Voltage

Operating Temperature

Max. Fuse Rated Current Front Static Load(snow,wind)

Back Static Load(wind)

31.01V

12.90A

37.07V

13.79A

20.5%

Power Tolerance

Cable Cross Section Size

Mono PERC 182 mm

1722±2 × 1134±2 × 35±1 mm

IP68 rated (3 bypass diodes)

in length or customized length 2.0mm AR Tempered glass 2.0mm Semi-tempered glass

36 pcs/Pallet, 936 pcs/ 40'HQ

Portrait: (-)350 mm and (+)160 mm

108 (6 × 18)

22.6kg (±3%) 4mm2(IEC), 12 AWG(UL)

DC 1500V

-40 C ~ +85 (

5400Pa(112lb/ft2)

2400Pa(50lb/ft²)

70%±10%

UL Type 29

395W

30.84V

12.81A

36.98V

13.70A

20.2%

Maximum Series Fuse Rating

Mechanical Characteristics

**Operating Parameters** 

30.64V

12.73A

36.85V

13.61A

20.0%

25 A

0/+5 W

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#### **TITAN SOLAR POWER**

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CONTRACTOR LIC# 14480 AND 150562

| REVIS       | SIONS |     |
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SIGNATURE WITH SEAL

DATE: 03/23/2023

PROJECT NAME & ADDRESS

LUCIA FUENTES RESIDENCE

110 E. WILLIAM ST., SALISBURY, MD 21801 PH#.:(410) 845-0824

SHEET NAME **EQUIPMENT SPECIFICATION** 

SHEET SIZE

**ANSI B** 11" X 17"

SHEET NUMBER

PV-8

extreme wind (2400 Pa) and snow loads (5400 Pa) Quality guarantee



# **Single Phase Inverter** with HD-Wave Technology

# for North America

SE3000H-US / SE3800H-US / SE5000H-US / SE6000H-US / SE7600H-US / SE10000H-US / SE11400H-US





# Optimized installation with HD-Wave technology

- Specifically designed to work with power optimizers
- Record-breaking 99% weighted efficiency
- Quick and easy inverter commissioning directly from a smartphone using the SolarEdge SetApp
- Fixed voltage inverter for longer strings
- Integrated arc fault protection and rapid shutdown for NEC 2014, NEC 2017 and NEC 2020 per article 690.11 and 690.12

- UL1741 SA certified, for CPUC Rule 21 grid compliance
- Built-in module-level monitoring
- Optional: Faster installations with built-in consumption metering (1% accuracy) and



/ Small, lightweight, and easy to install both outdoors or indoors

production revenue grade metering (0.5% accuracy,



**NVERTERS** 

# / Single Phase Inverter with HD-Wave Technology for North America

SE3000H-US / SE3800H-US / SE5000H-US / SE6000H-US/ SE7600H-US / SE10000H-US / SE11400H-US

| MODEL NUMBER   | SE3000H-US | SE3800H-US                 | SE5000H-US | SE6000H-US                    | SE7600H-US | SE10000H-US | SE11400H-US                  |    |
|--|------------|----------------------------|------------|-------------------------------|------------|-------------|------------------------------|----|
| APPLICABLE TO INVERTERS<br>WITH PART NUMBER                                  |            | SEXXXXH-XXXXXBXX4          |            |                               |            |             |                              |    |
| OUTPUT   | 700        |                            |            |                               |            |             | _                            |    |
| Rated AC Power Output  | 3000       | 3800 @ 240V<br>3300 @ 208V | 5000       | 6000 @ 240V<br>5000 @ 208V    | 7600       | 10000       | 11400 @ 240V<br>10000 @ 208V | VA |
| Maximum AC Power Output  | 3000       | 3800 @ 240V<br>3300 @ 208V | 5000       | 6000 @ 240V<br>5000 @ 208V    | 7600       | 10000       | 11400 @ 240V<br>10000 @ 208V | VA |
| AC Output Voltage MinNomMax.<br>(211 - 240 - 264)                            | ~          | ✓                          | <b>✓</b>   | <b>*</b>                      | <b>✓</b>   | <b>✓</b>    | ✓                            | Va |
| AC Output Voltage MinNomMax.<br>(183 - 208 - 229)                            | =          | ✓                          | 2          | ~                             | 2          | =           | ✓                            | Va |
| AC Frequency (Nominal)   |            |                            |            | 59.3 - 60 - 60.5 <sup>a</sup> | 1          |             |                              | Hz |
| Maximum Continuous Output<br>Current @240V                                   | 12.5       | 16                         | 21         | 25                            | 32         | 42          | 47.5                         | А  |
| Maximum Continuous Output<br>Current @208V                                   | =          | 16                         | -          | 24                            | 2          | -           | 48.5                         | А  |
| Power Factor   |            |                            | 1          | , Adjustable - 0.85 to        | 0.85       |             |                              |    |
| GFDI Threshold   |            |                            |            | 1                             |            |             |                              | A  |
| Utility Monitoring, Islanding Protection,<br>Country Configurable Thresholds |            |                            |            | Yes                           |            |             |                              |    |
| INPUT  |            |                            |            |                               |            |             |                              |    |
| Maximum DC Power @240V   | 4650       | 5900                       | 7750       | 9300                          | 11800      | 15500       | 17650                        | W  |
| Maximum DC Power @208V   |            | 5100                       | =          | 7750                          | =          | -           | 15500                        | W  |
| Transformer-less, Ungrounded   |            |                            |            | Yes                           |            |             |                              |    |
| Maximum Input Voltage  |            | _                          |            | 480                           | 3          |             |                              | Vd |
| Nominal DC Input Voltage   |            |                            | 380        |                               |            | 400         |                              | Vd |
| Maximum Input Current @240V <sup>2)</sup>                                    | 8.5        | 10.5                       | 13.5       | 16.5                          | 20         | 27          | 30.5                         | Ad |
| Maximum Input Current @208V <sup>(2)</sup>                                   | 5          | 9                          | -          | 13.5                          | =          | -           | 27                           | Ad |
| Max. Input Short Circuit Current   |            |                            |            | 45                            |            |             |                              | Ac |
| Reverse-Polarity Protection  |            |                            |            | Yes                           |            |             |                              |    |
| Ground-Fault Isolation Detection   |            |                            |            | 600ko Sensitivity             |            |             |                              |    |
| Maximum Inverter Efficiency  | 99         |                            |            | ç                             | 9.2        |             |                              | %  |
| CEC Weighted Efficiency  |            | 99 @ 240V<br>98.5 @ 208V   |            |                               |            |             | %                            |    |
| Nighttime Power Consumption  |            |                            |            | < 2.5                         |            |             |                              | W  |

(1) For other regional settings please contact SolarEdge support
(2) A higher current source may be used; the inverter will limit its input current to the values stated



## TITAN SOLAR POWER

160 N MCQUEEN RD, GILBERT, AZ 85233, USA

PHONE: (808) 371-5338 TITAN SOLAR POWER

| REVISIONS   |      |     |  |
|-------------|------|-----|--|
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SIGNATURE WITH SEAL

DATE: 03/23/2023

PROJECT NAME & ADDRESS

SHEET NAME **EQUIPMENT SPECIFICATION** 

SHEET SIZE

**ANSIB** 11" X 17"

SHEET NUMBER

PV-9

solaredge.com

# Single Phase Inverter with HD-Wave Technology for North America


SE3000H-US / SE3800H-US / SE5000H-US / SE6000H-US/ SE7600H-US / SE10000H-US / SE11400H-US

| MODEL NUMBER   | SE3000H-US | SE3800H-US   | SE5000H-US             | SE6000H-US             | SE7600H-US          | SE10000H-US         | SE11400H-US        |       |
|--|------------|--|------------------------|------------------------|---------------------|---------------------|--------------------|-------|
| ADDITIONAL FEATURES                                      | A          |  |                        |                        |                     |                     | "                  |       |
| Supported Communication Interfaces                       |            | RS485, Ethernet, ZigBee (optional), Cellular (optional)                      |                        |                        |                     |                     |                    |       |
| Revenue Grade Metering, ANSI C12.20                      |            |  |                        | 0 1 13                 |                     |                     |                    |       |
| Consumption metering                                     |            |  |                        | Optional <sup>®</sup>  |                     |                     |                    |       |
| Inverter Commissioning                                   |            | With the SetA  | pp mobile applicatio   | n using Built-in Wi-Fi | Access Point for Lo | cal Connection      |                    |       |
| Rapid Shutdown - NEC 2014, NEC 2017 and NEC 2020, 690.12 |            |  | Automatic Rapid        | Shutdown upon AC       | Grid Disconnect     |                     |                    |       |
| STANDARD COMPLIANCE                                      | W-         |  |                        |                        |                     |                     |                    |       |
| Safety   |            | UL1741, UL1741 SA, UL1699B, CSA C22.2, Canadian AFCI according to T.I.L M-07 |                        |                        |                     |                     |                    |       |
| Grid Connection Standards                                |            |  | IEEE:                  | 1547, Rule 21, Rule 14 | (HI)                |                     |                    |       |
| Emissions  |            |  |                        | FCC Part 15 Class B    |                     |                     |                    |       |
| INSTALLATION SPECIFICAT                                  | IONS       |  |                        |                        |                     |                     |                    |       |
| AC Output Conduit Size / AWG Range                       |            | 1"   | Maximum / 14-6 AV      | VG                     |                     | 1" Maximum          | /14-4 AWG          |       |
| DC Input Conduit Size / # of Strings /<br>AWG Range      |            | 1" Maxir   | mum / 1-2 strings / 1- | 4-6 AWG                |                     | 1" Maximum / 1-3 :  | strings / 14-6 AWG |       |
| Dimensions with Safety Switch (HxWxD)                    |            | 17.7 x   | 14.6 x 6.8 / 450 x 37  | '0 x 174               |                     | 21.3 x 14.6 x 7.3 / | 540 x 370 x 185    | in/mm |
| Weight with Safety Switch                                | 22 /       | /10  | 25.1 / 11.4            | 26.2                   | / 11.9              | 38.8                | 17.6               | lb/kg |
| Noise  |            | <  | 25                     |                        |                     | <50                 |                    | dBA   |
| Cooling  |            |  |                        | Natural Convection     |                     |                     |                    |       |
| Operating Temperature Range                              |            | -40 to +140 / -40 to +60 <sup>.4</sup>                                       |                        |                        |                     | *F/*C               |                    |       |
| Protection Rating  |            | NEMA 4X (Inverter with Safety Switch)  |                        |                        |                     |                     |                    |       |

<sup>(3)</sup> Inverter with Revenue Grade Meter P/N: SExxxxH-US000BNC4; inverter with Revenue Grade Production and Consumption Meter P/N: SExxxxH-US000BNI4 . For consumption metering, current transformers should be ordered separately; SEACT0750-200NA-20 or SEACT0750-400NA-20. 20 units per box

# **How to Enable Consumption Monitoring**

By simply wiring current transformers through the inverter's existing AC conduits and connecting them to the service panel, homeowners will gain full insight into their household energy usage helping them to avoid high electricity bills

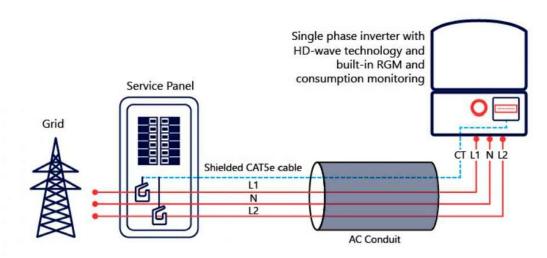

#### TITAN SOLAR POWER

160 N MCQUEEN RD, GILBERT, AZ 85233, USA

# PHONE: (808) 371-5338 TITAN SOLAR POWER

CONTRACTOR LIC# 14480 AND 150562

| REVISIONS   |      |     |  |
|-------------|------|-----|--|
| DESCRIPTION | DATE | REV |  |
|             |      |     |  |
|             |      |     |  |
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SIGNATURE WITH SEAL

DATE: 03/23/2023

PROJECT NAME & ADDRESS

UCIA FUENTES RESIDENCE

110 E. WILLIAM ST., SALISBURY, MD 21801 PH#.:(410) 845-0824

SHEET NAME
EQUIPMENT
SPECIFICATION

SHEET SIZE

ANSI B 11" X 17"

SHEET NUMBER

PV-9A

<sup>(4)</sup> Full power up to at least 50°C / 122°F; for power de-rating information refer to: https://www.solaredge.com/sites/default/files/se-temperature-derating-note-napdf

# **Power Optimizer** For Residential Installations

S440 / S500 / S500B



# Enabling PV power optimization at the module level

- Specifically designed to work with SolarEdge residential inverters
- Detects abnormal PV connector behavior, preventing potential safety issues\*
- Module-level voltage shutdown for installer and firefighter safety
- Superior efficiency (99.5%)

- Mitigates all types of module mismatch loss, from manufacturing tolerance to partial shading
- Faster installations with simplified cable management and easy assembly using a single bolt
- Flexible system design for maximum space utilization
- Compatible with bifacial PV modules



# / Power Optimizer For Residential Installations

S440 / S500 / S500B

|  | S440               | S500                              | S500B             | UNIT |
|--|--------------------|-----------------------------------|-------------------|------|
| INPUT  |                    |                                   | in .              |      |
| Rated Input DC Power <sup>(1)</sup>                        | 440                | 8                                 | 500               | W    |
| Absolute Maximum Input Voltage (Voc)                       | 6                  | 0                                 | 125               | Vdc  |
| MPPT Operating Range                                       | 8-                 | 60                                | 12.5 – 105        | Vdc  |
| Maximum Short Circuit Current (Isc) of Connected PV Module | 14.5               |                                   | 15                | Adc  |
| Maximum Efficiency   |                    | 99.5                              |                   | %    |
| Weighted Efficiency  |                    | 98.6                              |                   | %    |
| Overvoltage Category                                       |                    | II                                |                   |      |
| OUTPUT DURING OPERTION                                     |                    |                                   |                   |      |
| Maximum Output Current                                     |                    | 15                                |                   | Adc  |
| Maximum Output Voltage                                     | 6                  | 0                                 | 80                | Vdc  |
| OUTPUT DURING STANDBY (POWER OPTIMIZER D                   | DISCONNECTED FROM  | INVERTER OR INVER                 | TER OFF)          |      |
| Safety Output Voltage per Power Optimizer                  |                    | 1 ± 0.1                           | 9/                | Vdc  |
| STANDARD COMPLIANCE(2)                                     |                    |                                   |                   |      |
| EMC  | FCC Part 15 Class  | B, IEC61000-6-2, IEC61000-6-3,    | CISPR11, EN-55011 |      |
| Safety   |                    | EC62109-1 (class II safety), UL17 | 41                |      |
| Material   |                    | UL94 V-0, UV Resistant            |                   |      |
| RoHS   |                    | Yes                               |                   |      |
| Fire Safety  |                    | VDE-AR-E 2100-712:2013-05         |                   |      |
| INSTALLATION SPECIFICATIONS                                |                    |                                   |                   |      |
| Maximum Allowed System Voltage                             |                    | 1000                              |                   | Vdc  |
| Dimensions (W x L x H)                                     | 129 x 15           | 55 x 30                           | 129 x 155 x 45    | mm   |
| Weight (including cables)                                  |                    | 655                               |                   | gr   |
| Input Connector  | MC4 <sup>(3)</sup> |                                   |                   |      |
| Input Wire Length  | 0.1                |                                   | m                 |      |
| Output Connector   | MC4                |                                   |                   |      |
| Output Wire Length   | (+) 2.3, (-) 0.10  |                                   | m                 |      |
| Operating Temperature Range <sup>(4)</sup>                 | -40 to +85         |                                   | °C                |      |
| Protection Rating  |                    | IP68                              |                   |      |
| Relative Humidity  |                    | 0 - 100                           |                   | %    |


(1) Rated power of the module at STC will not exceed the Power Optimizer Rated Input DC Power. Modules with up to +5% power tolerance are allowed.

(2) For details about CE compliance, see <u>Declaration of Conformity - CE</u>.

(4) For ambient temperature above +70°C power de-rating is applied. Refer to Power Optimizers Temperature De-Rating Technical Note for details.

| PV System Design I<br>Inverter <sup>(5)</sup>                                | Jsing a SolarEdge       | SolarEdge Home<br>Wave Single Phase | Three Phase<br>SExxK-RWB | Three Phase for 230/400V Grid | Three Phase for<br>277/480V Grid |   |
|--|-------------------------|-------------------------------------|--------------------------|-------------------------------|----------------------------------|---|
| Minimum String Length  | S440, S500              | 8                                   | 9                        | 16                            | 18                               |   |
| (Power Optimizers)   | S500B                   | 6                                   | 8                        | 1                             | 4                                |   |
| Maximum String Length (P   | ower Optimizers)        | 25                                  | 20                       | 5                             | 0                                |   |
| Maximum Continuous Pow   | er per String           | 5700                                | 5625                     | 11250                         | 12750                            | W |
| Maximum Allowed Connec<br>(Permitted only when the powe<br>less than 2,000W) |                         | See®                                | See <sup>(6)</sup>       | 13500                         | 15000                            | W |
| Parallel Strings of Different  | Lengths or Orientations |                                     | Yε                       | es                            |                                  |   |

(5) It is not allowed to mix S-series and P-series Power Optimizers in new installations,
(6) If the inverter's rated AC power s maximum nominal power per string, then the maximum power per string will be able to reach up to the inverters maximum input DC power. Refer to Application Note: Single String Design Guidelines

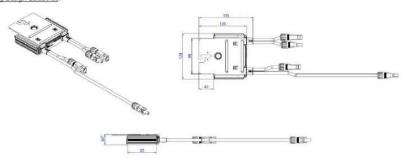

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**(€ RoHS** 



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DATE: 03/23/2023

PROJECT NAME & ADDRESS

LUCIA FUENTES RESIDENCE

SHEET NAME **EQUIPMENT SPECIFICATION** 

SHEET SIZE

**ANSIB** 11" X 17"

SHEET NUMBER

<sup>\*</sup> Functionality subject to inverter model and firmware version



# TECHNICAL SHEET

| Item Number | Description          | Part Number                       |
|-------------|----------------------|-----------------------------------|
| 1           | Splice Foot X        | 4000113   Splice Foot X Kit, Mill |
| 2           | K2 FlexFlash Butyl   |                                   |
| 3           | M5 x 60 lag screws   |                                   |
| 4           | T-Bolt & Hex Nut Set |                                   |


#### Technical Data


|                 | Splice Foot X                          |
|-----------------|--|
| Roof Type       | Composition shingle                    |
| Material        | Aluminum with stainless steel hardware |
| Finish          | Mill                                   |
| Roof Connection | M5 x 60 lag screws                     |
| Code Compliance | UL 2703                                |
| Compatibility   | CrossRail 44-X, 48-X, 48-XL, 80        |

We support PV systems Formerly Everest Solar Systems



Units: [in] mm

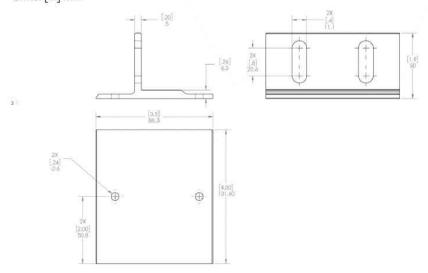

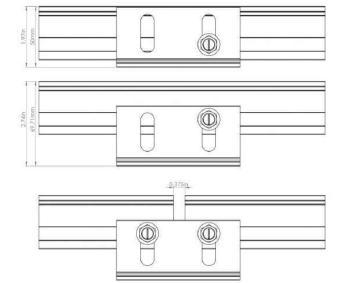

k2-sys



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SHEET NAME
EQUIPMENT
SPECIFICATION

SHEET SIZE


ANSI B 11" X 17"

SHEET NUMBER

# **CONNECTING STRENGTH**



Units: [mm] in

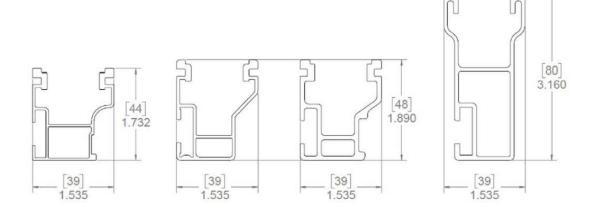

## Technical Data

|                     | CrossRail System  |
|---------------------|---|
| Roof Type           | Composition shingle, tile, standing seam                                  |
| Material            | High corrosion resistance stainless steel and high grade aluminum         |
| Flexibility         | Modular construction, suitable for any system size, height adjustable     |
| PV Modules          | For all common module types   |
| Module Orientation  | Portrait and landscape  |
| Roof Connection     | Drill connection into rafter  |
| Structural Validity | IBC compliant, stamped engineering letters available for all solar states |
| Warranty            | 25 years  |

# **CONNECTING STRENGTH**



# CROSSRAIL 44-X



k2-systems.com


# Mechanical Properties

|                           | CrossRail 44-X           |
|---------------------------|--------------------------|
| Material                  | 6000 Series Aluminum     |
| Ultimate Tensile Strength | 37.7 ksi [260 MPa]       |
| Yield Strength            | 34.8 ksi (240 MPa)       |
| Weight                    | 0.47 lbs/ft [0.699 kg/m] |
| Finish                    | Mill or Dark Anodized    |

# Sectional Properties

|               | CrossRail 44-X          |
|---------------|-------------------------|
| Sx            | 0.1490 in3 (0.3785 cm3) |
| Sy            | 0.1450 in3 (0.3683 cm3) |
| A (X-Section) | 0.4050 in2 (1.0287 cm2  |

# Units: [mm] in

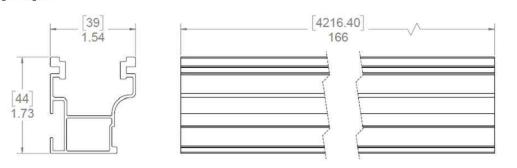

#### Notes:

- Structural values and span charts determined in accordance with Aluminum Design Manual and ASCE 7-16
- UL2703 Listed System for Fire and Bonding

**(1)** 

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SHEET NAME
EQUIPMENT
SPECIFICATION

SHEET SIZE

ANSI B 11" X 17"

SHEET NUMBER

PV-12

k2-systems.com



Intertek 3933 US Route 11 Cortland, NY 13045 Telephone: 607-753-7311 www.intertek.com

Subject: ETL Evaluation of SolarEdge Products to Rapid Shutdown Requirements

To, whom it may concern

This letter represents the testing results of the below listed products to the requirements contained in the following standards:

The evaluation was done on the PV Rapid Shutdown System (PVRSS), and covers installations consisting of optimizers and inverters with part numbers listed below.

The testing done has verified that controlled conductors are limited to:

- Not more than 30 volts and 240 voltamperes within 30 seconds of rapid shutdown initiation outside the array.
- Not more than 80 volts and 240 voltamperes within 30 seconds of rapid shutdown initiation inside the array.

The rapid shutdown initiation is performed by either disconnecting the AC feed to the inverter, or – if the inverter DC Safety switch is readily accessible – by turning off the DC Safety switch.

#### Applicable products:

(1) Power optimizers:

PB followed by 001 to 350; followed by -AOB or -TFI.
OP followed by 001 to 500; followed by -LV, -MV, -IV or -EV.
P followed by 001 to 1100.

SP followed by 001 to 350.

When optimizers are connected to 2 or more modules in series, the max input voltage may exceed 80V. Following the implementation of the NEC 2017 rapid shutdown value of 80V max inside of the array at the beginning of 2019, modules exceeding this combined input max voltage will be required to use optimizers with parallel inputs. Also meeting NEC 2020 rapid shutdown requirement.

## (2) 1 -PH Inverters

 $SE3000A-US\ /\ SE3800A-US\ /\ SE5000A-US\ /\ SE6000A-US\ /\ SE7600A-US\ /\ SE10000A-US\ /\ SE11400A-US\ /\ SE3000H-US\ /\ SE3000H-US\ /\ SE3000H-US\ /\ SE10000H-US\ /\ SE10000H-US\ /\ SE11400H-US\ when the following label is labeled on the side of the inverter:$ 

Inverter part number may be followed by a suffix.

(3) 3 -PH Inverters



Intertek 3933 US Route 11 Cortland, NY 13045 Telephone: 607-753-7311 www.intertek.com

SE9KUS / SE10KUS / SE14.4KUS/ SE16.7kUS / SE17.3kUS / SE20KUS/ SE24KUS / SE30KUS / SE33.3KUS / SE40KUS / SE43.2KUS / SE50KUS / SE66.6KUS / SE80KUS / SE85KUS / SE100KUS / SE120KUS; when the following label is labeled on the side of the inverter:

Please note, this Letter Report does not represent authorization for the use of any Intertek certification marks.

Brand Name(s) SolarEdge

Relevant Standard(s) UL 1741, UL 1741 CRD for rapid shutdown

National Electric Code, 2020, Section 690.12 requirement for

rapid shutdown

Verification Issuing Office 3933 US Route 11, Cortland, NY 13045

NRTL Disdaimer, Different for each NRTL – Example: "This Verification is for the exclusive use of NRTL'S Client and is provided pursuant to the agreement between NRTL and its Client. NRTL's responsibility and liability are limited to the terms and conditions of the agreement. NRTL assumes no liability to any party, other than to the Client in accordance with the agreement, for any loss, expense or damage occasioned by the use lib Verification. Only the Client is authorized to copy or distribute this Verification. Any use of the NRTL name or one of its marks for the sale or advertisement of the tested material, product or service must first be approved in writing by NRTL. The observations and test results referenced from this Verification by itself does not imply that the material, product, or service is or has ever been under an NRTL certification program."

Signature:

Name: Mukund Rana Position: Staff Engineer Date:5/17/2021



Intertek 3933 US Route 11 Cortland, NY 13045 Telephone: 607-753-7311

| Date                       | Engineer /<br>Reviewer | Description  |
|----------------------------|------------------------|--|
| 5/17/2021<br>G104683664CRT | Dishant Patel          | Added New 3-PH Inverter model SE50KUS, SE80KUS, SE85KUS and SE120KUS.  |
|                            | Mukund Rana            | Updated Power optimizers from "P followed by 001 to 960" to "P followed by 001 to 1100"  |
|                            |                        | Updated NEC standard from "National Electric Code, 2017, Section 690.12 requirement for rapid shutdown" To "National Electric Code, 2020, Section 690.12 requirement for rapid shutdown" |



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SHEET NAME

EQUIPMENT SPECIFICATION

SHEET SIZE

ANSI B 11" X 17"

SHEET NUMBER

# RECOMMENDED OCPD SIZE PER GRID:

|  | SE3000H-US | SE3800H-US                 | SE5000H-US | SE6000H-US                    | SE7600H-US | SE10000H-US | SE11400H-US  | Unit                |
|--|------------|----------------------------|------------|-------------------------------|------------|-------------|--------------|---------------------|
| OUTPUT                                       |            |                            |            |                               |            |             |              |                     |
| Rated AC Power Output                        | 3000       | 3800 @ 240V<br>3300 @ 208V | 5000       | 6000 @ 240V<br>5000 @ 208V    | 7600       | 10000       | 11400        | VA                  |
| Max AC Power Output                          | 3000       | 3800 @ 240V<br>3300 @ 208V | 5000       | 6000 @ 240V<br>5000 @ 208V    | 7600       | 10000       | 11400        | VA                  |
| AC Output Voltage<br>MinNomMax.(183-208-229) | (4)        | <b>~</b>                   | 18.        | ~                             | 181        | 1=1         | le!          | Vac                 |
| AC Output Voltage<br>MinNomMax.(211-240-264) | ~          | 1                          | <b>✓</b>   | <b>V</b>                      | 1          | 1           | ₹.           | Vac                 |
| AC Frequency (Nominal)                       |            |                            |            | 59.3 - 60 - 60.5 <sup>1</sup> |            | •           |              | Hz                  |
| Maximum Continuous Output<br>Current 208V    | 17.0       | 16                         |            | 25                            | =          | 130         | ( <b>1</b> ) | Α                   |
| Maximum Continuous Output<br>Current 240V    | 12.5       | 16                         | 21         | 25                            | 32         | 42          | 47.5         | Α                   |
| Max. output fault current and duration @208V | a)         | 17.5/20                    | N=1        | 27.5/20                       | =          | 790         | 12/          | A/ms                |
| Max. output fault current and duration @240V | 14/20      | 17.5 / 20                  | 23 / 20    | 27.5/20                       | 40 / 20    | 56.6        | 6/ 20        | A/ms                |
| Inrush current AC (Peak/ Duration)           |            |                            | 2.8/20     |                               |            | 3.45        | 5/ 20        | Aac<br>(rms)/<br>ms |
| Max. output overcurrent protection           | 3          | 15                         | 4          | 8                             | 55         | 8           | 0            | Α                   |



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ANSI B 11" X 17"

SHEET NUMBER

# Salisbury Historic District Commission

# **STAFF FINDINGS**

# Meeting of July 26, 2023

Case Number: #23-16

**Commission Considering:** Solar Panels

Owner Name:

Owners Address:

Lucia Fuentes

110 E William St

Salisbury, MD 21801

Applicant Name: Kadeidra Jarrett

**Applicant's Address:** 525 W Baseline Road

Mesa, AZ 85210

Agent/Contractor: Titan Solar Panel

**Subject Property Address:** 110 E William St

**Historic District:** Newtown Historic District

Use Category: Commercial

**Zoning Classification:** R-5

**Structure / Site Description:** 

Built Date: 1920

**Enclosed Area:** 2,792 sq. ft.

**Lot Size:** 6,958 sq. ft.

**Number of Stories:** 2

**Contributing Structure:** Yes 8/22/2012

**Wicomico County Historic Survey on file:** No

**Nearby Properties on County Survey:** Yes

## **Including but not limited to:**

112 E wiiliam St- J. Clarence Parker House 106 E William St- Albert, W Lankford

**Explanation of Request:** The applicant is seeking approval to add 24 Solar Panels to roof.

#### Areas of Historic Guidelines to be considered:

#### **Guideline 31: Solar Panels**

a. Solar panels should be installed in a location that minimizes their visibility as much as possible. Flat roofs, and rear sloping roofs are the best candidates.

#### **Evaluation Criteria:**

Pursuant to Section 17.52.040 A & B of the Salisbury Zoning Code, it is the duty of the Historic District Commission to review all applications to construct, alter, reconstruct, move or demolish any structure within a Historic District whenever the exterior appearance of such structure is affected, and to approve or reject said application. In reviewing an application and plans, the Commission should give consideration to review criteria, and may make a determination as to which of said Criteria are applicable.

Staff Findings Prepared By: Jessica Budd Infrastructure and Development 125 N Division Street, Suite 202 Salisbury, MD 21801 (410) 548-3170

Date: July 17, 2023

|                      | View Wap     |                 |                             | View GroundNest I  | Redemption  |                    |             |              | Yes Groundfast I         | Segistration   |
|----------------------|--------------|-----------------|-----------------------------|--|-------------|--------------------|-------------|--------------|--------------------------|--|
|                      | lac Recays   |                 |                             |  |             |                    |             |              |                          |  |
| Associate            | Merallier.   |                 |                             | Chemics - 05.  | Account Nam | Ber -009019        |             |              |                          |  |
|                      |              |                 |                             |  | 0           | wner Information   | 1           |              |                          |  |
| Cener N              |              |                 |                             | FLENTED-01   | COTTLUCA    | 0                  | Dies        |              |                          | RESIDENTIAL.   |
|                      |              |                 |                             |  |             | 2                  | Petropa     | Residen      | an i                     | YES  |
| Marting A            | direct       |                 |                             | TO E WILLY   |             |                    | Dead Re     | derence      |                          | /84121/09038   |
|                      |              |                 |                             |  | Location    | & Structure Infor  | mution      |              |                          |  |
| Premise              | Address      |                 |                             | THE R WILLIAM STALLMENT OF THE STALLMENT |             |                    | Legal De    | nec riptions |                          | R.MIR SOFT<br>TYD E WILLIAMS ST<br>CITY OF SALIS   |
| Map:<br>TOTO         | G/W:<br>5003 | Parcett<br>0818 | Neighborhood:<br>9000784.23 | Sub-0<br>0000  | Deleases.   | Beclos             | Block       | Loti         | Assessment Year:<br>2002 | PM N   |
| Town is              | ALISBURY.    |                 |                             |  |             |                    |             |              |                          |  |
| Primary:             | Miracluse I  | aut.            | Above to                    | ade Living Area  |             | Pickled Estebal    | Area        |              | Property Land Area       | County U   |
| Stories              | Bases        | -               | Type                        | Extension  | Quality     | Publish Eath       | Garage      |              | totice of Major Impro    | and the same of th |
| ,                    | NO           | _               | STANDARD LINE               | SOMO/  | 1           | 314                | - Landy     |              |                          | 7.00   |
|                      |              |                 |                             |  |             | alue Information   |             |              |                          |  |
|                      |              |                 |                             | Base Value   |             | Water              |             | take in Au   | ness amerida.            |  |
|                      |              |                 |                             |  |             | Aust               |             | luf .        |                          | Aud  |
| Lend                 |              |                 |                             | 17.400   |             | 01/01/2022         | or          | Ministra     |                          | eneraliza  |
| Ingresse             | and the same |                 |                             | TO 800   |             | 118.000            |             |              |                          |  |
| Total:               |              |                 |                             | 87.600   |             | 136,600            | 10          | 190,000      |                          | 120,238  |
| Professor            | Sel Land     |                 |                             | .0   |             | 0                  |             |              |                          |  |
|                      |              |                 |                             |  | Tre         | ensfer Information | n           |              |                          |  |
| Dellar M             | CHEL ROS     | DERICK C        | W.                          |  | Date: CD1   | troops             |             |              | Price: 200.1             | 100  |
| Type: At             | MILLIMOT     | THIMPRO         | VEICE                       |  | Deedt: /0   | 4121/ 0000e        |             |              | Dee-63                   |  |
| Selber, St           | MIR INC.     |                 |                             |  | Date: DU    | 13/2008            |             |              | Prior: \$150             | .000   |
| Type: Rt             | MELENCO      | THIMPRO         | VIEW TOWN                   |  | Deedt:/0    | 283W 00383         |             |              | Deed3                    |  |
|                      | RPEL HW      |                 |                             |  | Date: 107   |                    |             |              | Plan. 200.               | 100  |
| Type: Alt            | MELENIT      | THIMPRO         | VED                         |  | Deed1: /t   | 1961/00016         |             |              | Gee-63                   |  |
|                      |              |                 |                             |  | Exe         | mption Informatio  | on          |              |                          |  |
| PARINTE              | sampl Ass    | -               |                             | Class  |             |                    | 01/01/20    | 22           |                          | 0701202  |
| County.              | 03           |                 |                             | 000  |             |                    | 0.00        |              |                          |  |
| State                |              |                 |                             | 1000   |             |                    | 0.00        |              |                          |  |
| Manholps<br>Trace of | tax Hecapi   | harte Mir-      |                             | 900  |             |                    | 8.08(0.00   |              |                          | a solo ao  |
| -                    | -            | -               |                             |  |             |                    |             |              |                          |  |
|                      |              |                 |                             | ,  | fomestea    | d Application Info | omation     |              |                          |  |
| Homeste              | ait Applica  | ries State      | e: No Application           |  |             |                    |             |              |                          |  |
|                      |              |                 |                             | Manne  |             | x Credit Applicati | on Informat | Man.         |                          |  |
|                      |              | Court Name      | dualities Status: No App    |  | WHIGHTS THE | x Credit Applicati | Date:       | bon          |                          |  |
|                      |              |                 | manufacture and alpha       | manufit .  |             |                    | Date:       |              |                          |  |

# Salisbury Historic District Commission

# **Hearing Notification**

July 26, 2023

**Hearing Date:** 

| Time:                            | 7:00 pm  |
|----------------------------------|--|
| Location:                        | Government Office Building<br>125 N. Division Street<br>Salisbury, MD. 21804<br>Room 301 |
| Case Number:                     | #23-17   |
| <b>Commission Considering:</b>   | New Construction   |
| Owner's Name:                    | St Francis De Sales  |
| Applicant Name:                  | Chris Mills  |
| Agent/Contractor:                | Not Indicated  |
| <b>Subject Property Address:</b> | 411 Wicomico St  |
| Historic District:               | Camden Historic District   |
| Use Category:                    | Residential  |
| Chairman:                        | Mr. Scott Saxman   |
| HDC Staff contact:               | Jessica Budd<br>Associate Planner I<br>(410) 548-3170                                    |

| 125 N. Division Street   | Downsit Annlineting   |
|--|---|
| Room 202   | Permit Application<br>\$50 Fee Received 4 12 23 (date)  |
| Salisbury, MD 21801  | CV # 1471   |
| (410) 548-3170/ fax (410) 548-3107   | OK# IH-11   |
| Date Submitted: 6/12/23  Date Accepted as Complete: 7/7/23   | Case #:   |
| Subject Location: 411 Wice mise Street   | 4   |
| Application by: Chais Mills  | Owner Name: St Frances de Sales   |
| Applicant Address: 8467 Rum Ridge Rd Delmer  | Owner Address: 514 Canden Ave.  |
| Applicant Phone: Md 21875 443-944-4797   | Owner Phone: 410 - 742 - 6443 Owner Email: Soccer mom 42 ki'ds @ acl. com   |
| Work Involves: Alterations X New Constructions   | Λ   |
| ★ Demolition Sign  | Awning Estimated Cost 175 K   |
| <b>DESCRIPTION OF WORK PROPOSED</b> (Please be specif  | ic. Attach sheet if space is inadequate) Type of  |
| material, color, dimensions, etc. must accompany applicati   | on. If signs are proposed, indicate material,   |
| method of attachment, position on building, size and front I   | ineal feet of building, size and position of all  |
| other signs on building, and a layout of the sign.   |   |
| See Submitted description  | on and pictures on  |
| The attached sheet   |   |
| The attacked Steam   |   |
| Are there any easements or deed restrictions for the extensions their approval.  |   |
| Do you intend to apply for Federal or State Rehabilitation Maryland Historical Trust staff? Yes X No   | on Tax Credits? If yes, have you contacted  |
| Do you intend to apply for Federal or State Rehabilitation  Maryland Historical Trust staff? Yes X No  If you have checked "Yes" to either of the above questions.   | on Tax Credits? If yes, have you contacted  |
| Do you intend to apply for Federal or State Rehabilitation  Maryland Historical Trust staff?Yes_XNo  | on Tax Credits? If yes, have you contacted  |
| Do you intend to apply for Federal or State Rehabilitation  Maryland Historical Trust staff? Yes X No  If you have checked "Yes" to either of the above questions.   | tions, please provide a copy of your approval talong with this application.  DTOBE FILED WITH APPLICATION Department of Infrastructure and Development at all the required attachments and/or failure of the cheduled meeting may result in postponement of the ation is denied, the same application cannot be vised that members of the Salisbury Historic District   |
| Do you intend to apply for Federal or State Rehabilitation Maryland Historical Trust staff?  Yes X No  If you have checked "Yes" to either of the above quest  letter from the Maryland Historic Trus  See Reverse Side for DOCUMENTS REQUIRE All required documents must be submitted to the City Planner, Dleast 30 days prior to the next public meeting. Failure to include applicant or his/her authorized representative to appear at the se application until the next regular scheduled meeting. If an application resubmitted for one year from date of such action. Please be additionally commission or staff, may visit the subject property prior to the second commission or staff, may visit the subject property prior to the second commission.   | tions, please provide a copy of your approval talong with this application.  ED TOBE FILED WITH APPLICATION Department of Infrastructure and Development at all the required attachments and/or failure of the cheduled meeting may result in postponement of the ation is denied, the same application cannot be vised that members of the Salisbury Historic District cheduled meeting date to familiarize themselves with the sand Design Guidelines are available for review in   |
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| Do you intend to apply for Federal or State Rehabilitation Maryland Historical Trust staff?  Yes X No  If you have checked "Yes" to either of the above quest  letter from the Maryland Historic Trust  See Reverse Side for DOCUMENTS REQUIRE All required documents must be submitted to the City Planner, Deast 30 days prior to the next public meeting. Failure to include applicant or his/her authorized representative to appear at the scapplication until the next regular scheduled meeting. If an applicate resubmitted for one year from date of such action. Please be additionally commission or staff, may visit the subject property prior to the scapping the project.  The Salisbury Historic District Commission Rules and Regulation the office of the Department of Infrastructure and Development for website: www.ci.salisbury.md.us.  I, or my authorized representative, will appear at the meeting of on as Scheduled by Commission (date). Will be the commission of the subject premises has been that said owner is in full agreement with this proposal.  Applicant's   | tions, please provide a copy of your approval talong with this application.  DTO BE FILED WITH APPLICATION Department of Infrastructure and Development at all the required attachments and/or failure of the cheduled meeting may result in postponement of the ation is denied, the same application cannot be vised that members of the Salisbury Historic District cheduled meeting date to familiarize themselves with the sand Design Guidelines are available for review in for the City of Salisbury as well as on the city's the Salisbury Historic District Commission  Out Sikoree June 16-22 Medica July 19-24  (c-14th fully informed of the alterations herein proposed and |

# C.E. MILLS GENERAL CONTRACTORS, INC. 8467 RUM RIDGE ROAD

DELMAR, MARYLAND 21875

Email- cemillsbuilding@comcast.net
Website- www.cemillsbuilding.com
Office/Fax- 410-341-0017
Cell- 443-944-4797
MHIC# 0083098
MHBR# 8612

June 08, 2023

To Whom It May Concern:

We propose to construct a 2,200 square foot non-heated grounds building on Parcel 1506 at 411 Wicomico Street, Salisbury, Maryland to be utilized to maintain parcels 1501, 1502, 1503, 1506, 1507, and 1508 that are all owned by St. Francis de Sales Church. The North boundary lot of 1508, East boundary lot of 1507, and West boundary lots of 1501 and 1503 border the proposed building lot of 1506.

The grounds building will replace a building destroyed by a storm fallen tree and a badly deteriorated 20' by 20' shed. We propose to demolish and replace the 20'  $\times$  20' shed utilizing the same footprint. The new 20'  $\times$  20' grounds building will attach to the 30'  $\times$  60' grounds building as depicted in the drawings.

The new building will consist of a vinyl Carolina beaded clay colored siding on the South, East, and West sides. Clay colored Hardy board will be used on the North and West sides where there is a walkway. Matching clay colored garage doors will be installed with stable door hardware.

# C.E. MILLS GENERAL CONTRACTORS, INC.

8467 RUM RIDGE ROAD DELMAR, MARYLAND 21875

Email- cemillsbuilding@comcast.net
Website- www.cemillsbuilding.com
Office/Fax- 410-341-0017
Cell- 443-944-4797
MHIC# 008309
MHBR# 8612

July 7, 2023

To: Wicomico Historic District Commission/Review Committee Government Office Building Room 301 125 N. Division St. Salisbury, MD 21801

## **Grounds Building Replacement**


at St. Francis de Sales on Riverside Drive

- 1. Clay color Certain Teed collection 6 1/2" Carolina Beaded siding.
- 2. Pebblestone clay color Georgia Pacific (GP) vented soffit.
- 3. Clay color GP beaded T2 solid porch ceiling soffit.
- 4. Clay color James Hardiboard on porch front areas.
- 5. Clay cottage style collection garage doors.
- 6. Matching GP charcoal black architectural shingles.
- 7. Colonial White 8" Board & Batten vertical siding by Vinyl Carpentry over porch gable.
- 8. White aluminum vinyl on fascia and rake gable boards.
- 9. White guttering and downspouts.
- 10. White vinyl 6"x 6" post sleeves over front porch post.

<sup>\*</sup>Note samples of the following products will be brought to the July 26th meeting for review.

# **Wicomico County**

District: 13 Account Number: 053456

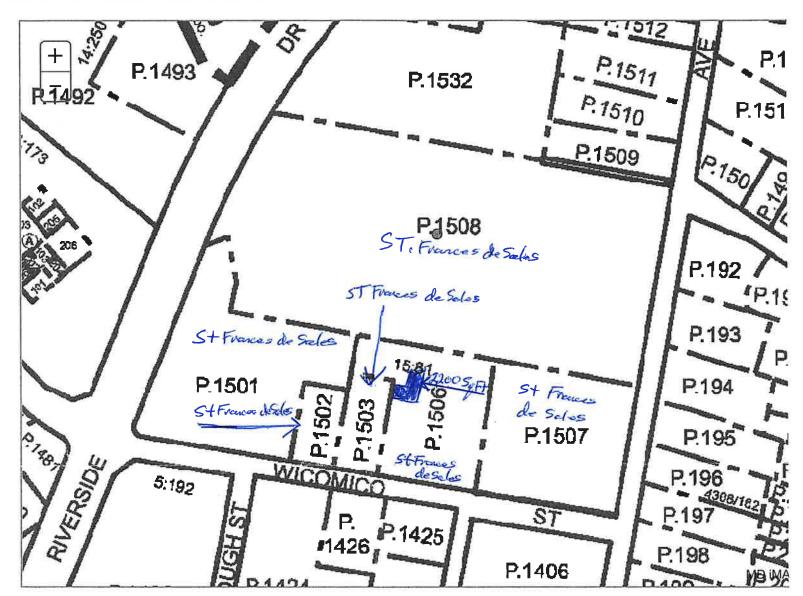

The information shown on this map has been compiled from deed descriptions and plats and is not a property survey. The map should not be used for legal descriptions. Users noting errors are urged to notify the Maryland Department of Planning Mapping, 301 W. Preston Street, Baltimore MD 21201.

If a plat for a property is needed, contact the local Land Records office where the property is located. Plats are also available online through the Maryland State Archives at <a href="http://www.plats.net">www.plats.net</a> (http://www.plats.net).

Property maps provided courtesy of the Maryland Department of Planning.

For more information on electronic mapping applications, visit the Maryland Department of Planning web site at <a href="http://planning.maryland.gov/Pages/OurProducts/OurProducts.aspx">http://planning.maryland.gov/Pages/OurProducts/OurProducts.aspx</a> (<a href="http://planning.maryland.gov/Pages/OurProducts/OurProducts.aspx">http://planning.maryland.gov/Pages/OurProducts/OurProducts.aspx</a>).


















k

NOTE; ALL WALLS TO BE 8" CONC. BLOCK, SEE WALL SECTION. INSTALL # 4 REBARS VERTICAL THRU 8" CONC. BLOCK I'-O" FROM ALL CORNERS AND (TYP) 4'-O" O.C. ON THE ENTIRE FOOTPRINT OF THE FOUNDATION. TIE REBARS INTO (E) BLOCK WALLS. ALL FOOTINGS SHALL BE PLACED ON SOLID UNDISTURBED SOIL. NOTE; ALL HEADERS SHALL BE 2-2"XIO" UNLESS NOTED.



# EFT SIDE ELEVATION

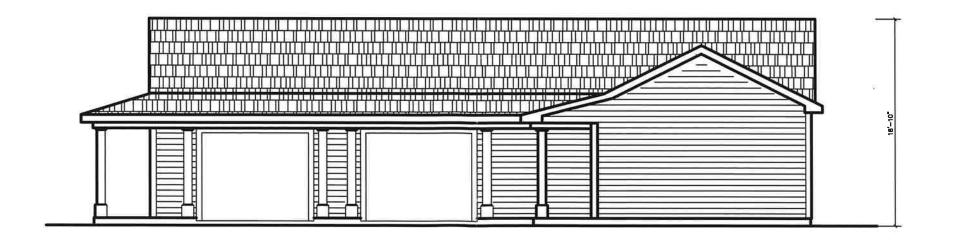

# FRONT ELEVATION

CONSTRUCTION CODE ANALYSIS:

V-B

2200 sq. ft

19,800 cu ft

CONSTRUCTION TYPE

TOTAL BUILDING AREA

NUMBER OF STORIES

VOLUME OF NEW STRUCTURE

HEIGHT

REVISED; 2-3-2023

REVISED; 2-2-2023


NOTE; CONTRACTOR IS TO VERIFY ALL BEAM LOCATIONS, LOLLY COLUMN LOCATIONS, AND ALL DIMENSIONS IN THE FIELD BEFORE BEGINNING CONSTRUCTION. DO NOT SCALE DRAWING

## NOTE;


CONTRACTOR IS TO SUPPLY SHOP DRAWINGS FOR ALL FLOOR JOIST, BEAMS, OPEN WEB WOOD FLOOR JOIST AND ALL ROOF TRUSSES.

ALL SHOP DRAWINGS SHALL BE SIGNED BY A LICENSED STRUCTURAL ENGINEER. NOTE; ALL WALLS TO BE 8" CONC. BLOCK, SEE WALL SECTION. INSTALL # 4 REBARS VERTICAL THRU 8" CONC. BLOCK I'-O" FROM ALL CORNERS AND (TYP) 4'-O" O.C. ON THE ENTIRE FOOTPRINT OF THE FOUNDATION. TIE REBARS INTO (E) BLOCK WALLS. ALL FOOTINGS SHALL BE PLACED ON SOLID UNDISTURBED SOIL.

NOTE; ALL HEADERS SHALL BE 2-2"XIO" UNLESS NOTED.

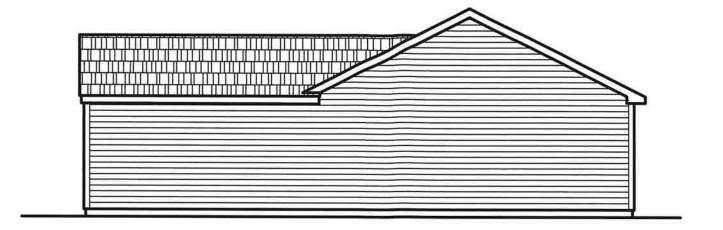

# RIGHT SIDE ELEVATION

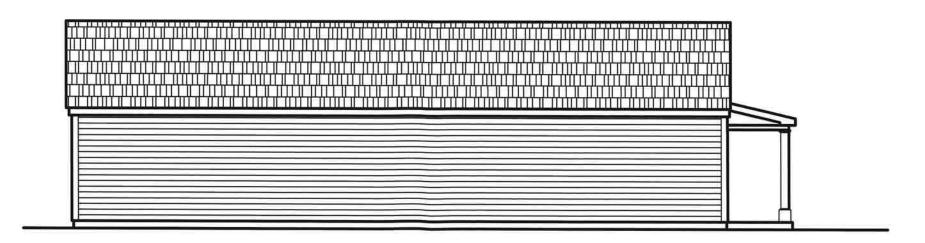

# REAR ELEVATION

REVISED; 2-3-2023

REVISED; 2-2-2023

CONSTRUCTION CODE ANALYSIS

USE GROUP

CONSTRUCTION TYPE

CONSTRUCTION TYPE V-8
NUMBER OF STORES 1

HBGHT 21-0"

TOTAL BUILDING AREA 2200 iq. ft
VOLUME OF NEW STRUCTURE 19,800 cu. ft



WILLIAM STUBBS STUDIO ARCHITECTURAL DESIGN

ST. FRANCIS DE SALES CHURCH 514 CAMPEN AVE. SAUSBURY, MD

FLEWRITIONS FGB 7, 2023



NOTE; CONTRACTOR IS TO VERIFY ALL BEAM LOCATIONS, LOLLY COLUMN LOCATIONS, AND ALL DIMENSIONS IN THE FIELD BEFORE BEGINNING CONSTRUCTION. DO NOT SCALE DRAWING

## NOTE;

CONTRACTOR IS TO SUPPLY SHOP DRAWINGS FOR ALL FLOOR JOIST, BEAMS, OPEN WEB WOOD FLOOR JOIST AND ALL ROOF TRUSSES.

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NOTE; ALL HEADERS SHALL BE 2-2"XIO" UNLESS NOTED.

WAREHOUSE CEILING HGT; 10'-0" RIDGE LINE <u>ō</u> 1/2"OSB SHEATHING FULL HEIGHT ON WALLS AS SHOWN 1/2"OSB SHEATHING — FULL HEIGHT ON WALLS AS SHOWN USE GROUP

NOTE; ALL SELECTIONS OF

MATERIAL, FLOORING CABINETS, SIDING, ROOFING AND WINDOWS ARE BY OWNER. FIRST FLOOR PLAN

CONSTRUCTION CODE AVALYSIS

CONSTRUCTION TYPE

NUMBER OF STORIES

TOTAL BUILDING AREA 2,200 mg, ft VOLUME OF NEW STRUCTURE 19,800 cu ft



STUDIO STUBBES

DESIGN **ARCHITECTURAL** WILLIAM

CHURCH SAILES 8

SAUSBURY, CAMPEN FIVE ST. FRANCIS 514

FLOOP PLANS

# MainStreet





# Salisbury Historic District Commission

## **STAFF FINDINGS**

## Meeting of July 26, 2023

**Case Number:** #23-17 **Commission Considering:** New Construction **Owner Name:** St Frances De Sales **Owners Address:** 514 Camden Ave Salisbury, MD 21801 **Chris Mills Applicant Name: Applicant's Address:** 8467 Rum Ridge Road Delmar, MD 21875 **Agent/Contractor:** C.E Mills General Contractor **Subject Property Address:** 411 Wicomico St **Historic District:** Camden Historic District Commercial **Use Category: Zoning Classification:** R-10**Structure / Site Description:** 1920 **Built Date: Enclosed Area:** 1,716 sq. ft. Lot Size: 36,483 sq. ft.

2

**TBD** 

**Number of Stories:** 

**Contributing Structure:** 

**Wicomico County Historic Survey on file:** Yes

**Nearby Properties on County Survey:** Yes

### **Including but not limited to:**

601 Camden Ave. – George C Hill House 513 Camden Ave. – R Frank Williams- Leatherbury House

**Explanation of Request:** The applicant is seeking approval to construct a new 2,200 square foot grounds building on Parcel 1506. Also, they would like to demolish and reconstruct a new 20 x 20 shed.

#### Areas of Historic Guidelines to be considered:

#### Guideline 36: New Construction

Building form is an important component of the streetscape, the largest element within the streetscape, and tends to command our attention most strongly. "Form" refers to the shape and massing of a building. Historic downtown commercial buildings, for example, often have a form that is boxy (rectangular), tall in proportion, and long or deep.

In planning new construction in downtown Salisbury, building form and streetscape elements should be carefully considered. Streetscape elements can reinforce the area's attractiveness and make it a desirable place to live or do business. Elements within the Downtown Historic District include a regular setback of building facades, which provides an unbroken view along the street and close placement of buildings.

- a. New structures should be similar in form, scale and height to the surrounding structures.
- b. New structures should be placed on existing vacant lots whenever possible, and should match the setback of surrounding structures. The vast majority of properties in the Downtown Historic District have little to no setback: the front of the building is positioned at the edge of the sidewalk.
- c. Parking lots or parking structures should be placed at the rear of the lot whenever possible. Ideally, access to them should be from a side street to lessen the number of curb cuts along main streets.
- d. New buildings should be compatible with adjacent structures in terms of massing, proportion, size, and scale.
- e. New buildings should be oriented to face the street rather than turned inward, skewed or oriented at angles to the existing street grid.
- f. Services such as delivery or trash removal should be handled from alleys that pass through the middle of the block or otherwise located on a non-visible elevation.
- g. Blank or windowless walls on the front façade or street side are not appropriate.

#### **Guideline 65: New Construction**

a. The new garage shall be compatible with the primary building in terms of scale, massing, and style.

b. Pre-fabricated, non-permanent sheds are permitted in the rear of the property. They should be small in scale and congruous with the style of the primary building.

#### **Evaluation Criteria:**

Pursuant to Section 17.52.040 A & B of the Salisbury Zoning Code, it is the duty of the Historic District Commission to review all applications to construct, alter, reconstruct, move or demolish any structure within a Historic District whenever the exterior appearance of such structure is affected, and to approve or reject said application. In reviewing an application and plans, the Commission should give consideration to review criteria, and may make a determination as to which of said Criteria are applicable.

Staff Findings Prepared By: Jessica Budd Infrastructure and Development 125 N Division Street, Suite 202 Salisbury, MD 21801 (410) 548-3170 Date: July 17, 2023

View Map View GroundRent Redemption View GroundRent Registration Special Tax Recapture: None Account Identifier: District - 13 Account Number - 046964 Owner Information Owner Name: SAINT FRANCIS DE SALES CHURCH EXEMPT COMMERCIAL Principal Residence: Mailing Address: 514 CAMDEN AVE Deed Reference: /01440/ 00338 SALISBURY MD 21801 Location & Structure Information 411 WICOMICO ST Premises Address: Legal Description: 36,483 SQFT SALISBURY 21801-0000 411-413 WICOMICO ST RESUB ST FRANCIS DESALES Map: Grid: Parcel: Neighborhood: Subdivision: Section: Block: Lot: Assessment Year: Plat No: 0111 0010 1506 10001.23 0000 2022 Plat Ref: 0015/0081 Town: SALISBURY **Primary Structure Built** Above Grade Living Area Finished Basement Area Property Land Area County Use 1920 1,716 SF 36,483 SF Stories Basement Type Quality Full/Half Bath Garage Last Notice of Major Improvements 2 NO STANDARD UNIT 3 1 full Value Information Base Value Value Phase-in Assessments As of As of As of 01/01/2022 07/01/2022 07/01/2023 Land: 218,800 218.800 Improvements 75,100 79,400 Total: 293,900 298,200 295.333 296.767 Preferential Land:

#### Transfer Information

Seller: JENION, WILLIAM R JR ETAL Date: 05/24/1995 Price: \$175,000 Type: ARMS LENGTH MULTIPLE Deed1: /01440/ 00338 Deed2: Seller: JENTON, WILLIAM R JR ETAL Date: 12/10/1986 Price: \$0 Type: NON-ARMS LENGTH OTHER Deed1: /01086/ 00754 Deed2: Seller: TODD, SAMUEL J E Date: 08/22/1986 Price: \$125,000 Deed1: /01075/ 00039 Type: NON-ARMS LENGTH OTHER Deed2:

#### **Exemption Information**

Partial Exempt Assessments: Class 07/01/2022 07/01/2023 County: 700 295 333 00 296.767.00 State: 700 295 333 00 296.767.00 Municipal: 700 295.333.00(296.767.00 295.333.00(296.767.00

Special Tax Recapture: None

#### Homestead Application Information

Homestead Application Status: No Application

#### Homeowners' Tax Credit Application Information

Homeowners' Tax Credit Application Status: No Application

Date:

## WI-552

## Camden Historic District (a.k.a. Newton)

#### **Architectural Survey File**

This is the architectural survey file for this MIHP record. The survey file is organized reverse-chronological (that is, with the latest material on top). It contains all MIHP inventory forms, National Register nomination forms, determinations of eligibility (DOE) forms, and accompanying documentation such as photographs and maps.

Users should be aware that additional undigitized material about this property may be found in on-site architectural reports, copies of HABS/HAER or other documentation, drawings, and the "vertical files" at the MHT Library in Crownsville. The vertical files may include newspaper clippings, field notes, draft versions of forms and architectural reports, photographs, maps, and drawings. Researchers who need a thorough understanding of this property should plan to visit the MHT Library as part of their research project; look at the MHT web site (mht.maryland.gov) for details about how to make an appointment.

All material is property of the Maryland Historical Trust.

Last Updated: 08-29-2003

## MARYLAND HISTORICAL TRUST NR-ELIGIBILITY REVIEW FORM

| NR | Eligible: | yes | X |
|----|-----------|-----|---|
|    |           | no  |   |

| Property Name:      | Camde      | n Historic I  | District (aka N | lewton) In    | nventory   | Number        | :: <u>WI-5</u> | 552       |          |                |             |       |       |
|---------------------|------------|---------------|-----------------|---------------|------------|---------------|----------------|-----------|----------|----------------|-------------|-------|-------|
| Address:            |            |               |                 | City: S       | alisbury   |               |                |           | _Zip(    | Code:          |             |       |       |
| County: W           | icomico    |               | US              | SGS Topog     | raphic N   | Лар: <u>S</u> | Salisbu        | ry Qua    | d        |                |             |       |       |
| Owner:              |            |               |                 |               |            |               |                |           |          |                | <del></del> |       |       |
| Tax Parcel Num      | ber:       | Tax M         | ap Number: _    | T             | ax Acco    | unt ID N      | umber          | :         |          |                | _           |       |       |
| Project:            |            |               |                 |               | Ageno      | cy:           |                |           |          |                |             |       |       |
| Site visit by MH    | T Staff:   | no            | <u>X</u> yes    | Name:         | Andrey     | v Lewis/I     | Michae         | l Day_    | D:       | ate: <u>03</u> | /23/01      |       |       |
| Eligibility recom   | mended     | <u>X</u>      |                 |               | Eligib     | ility not     | recom          | mende     | d        | _              |             |       |       |
| Criteria: X         | A          | B_X_C_        | D               | Consider      | ations:    | A             | _в             | _c_       | _D_      | _E             | _F          | _G _  | _None |
| Is the property lo  | ocated wi  | thin a histo  | ric district? _ | no            | yes        | Name o        | of distri      | ict:      |          |                |             |       |       |
| Is district listed? | no         | yes           | Determined      | eligible? _   | no         | yes           | D              | istrict l | Invento  | ory Nu         | nber:       | WI-55 | 2     |
| Documentation of    | on the pro | operty/distri | ct is presente  | d in:         |            |               |                |           |          |                |             |       |       |
| Description of Pr   | operty ar  | nd Eligibilit | y Determinati   | ion: (Use con | ıtinuation | sheet if nec  | essary a       | nd attac  | h map ai | nd photo       | )           |       |       |

The Camden Historic District (aka the Newton-Camden Historic District) is a local historic district composed of homes of a wide variety of architectural styles. According to information contained in the Wicomico survey files, the district was determined eligible by "Lukenbach & Andreve" on April 17, 1986, but no copy of the DOE form could be found. Nevertheless, the district contains numerous homes with a great deal of integrity and the earlier determination of eligibility still appears valid. Architectural styles represented within the district include Colonial Revival, Queen Anne and other Victorian styles. The City of Salisbury specifically identifies some of the homes in the area to be of "great historical value to the community". These homes include "the Humphrey House, Red Gables and the house known as "Cricket Box"". The City Ordinance establishing the district also included the following findings:

- Camden Avenue was once the main highway connecting Salisbury with Princess Anne to the south crossing the 18<sup>th</sup>
  Century Mill Dam at Tony Tank and Allen. It continued through the heart of Salisbury running northward to the Delaware
  towns.
- The Camden area was the location of the first known sanitary sewer installed in 1887 to serve the L.W. Gunby and William P. Jackson homes on Camden Avenue.
- After the fire of 1886, City Board of Commissioners established a series of ordinances which included maintaining sidewalks in front of properties and establishing the rights of way of various streets. Among the first streets subject to improvement of widening and straightening in 1887 under this law was Camden Street, now Camden Avenue.


| MARYLAND HISTORICAL TRUST REVIE      | EW              |          | _ <del></del> |              |      |                  |    |    |      |          |
|--------------------------------------|-----------------|----------|---------------|--------------|------|------------------|----|----|------|----------|
| Eligibility recommended              | <u> </u>        | y not re | comme         | ended        |      |                  | _  |    |      |          |
| Criteria: XA_B_V_C_D                 | Considerations: | A        | _B            | _C           | _D   | _E_              | F_ | G_ | None |          |
| Comments:                            |                 |          |               |              |      |                  |    |    |      | 9        |
|                                      |                 |          |               |              |      |                  |    |    |      | M        |
| A                                    |                 |          |               |              | /    | <del>-/-</del> . |    |    | (    | $\vee V$ |
| Homew Lewis                          |                 |          |               | <u>0</u> 5,  | 102  | -/0              |    |    |      |          |
| Reviewer, Office of Preservation Ser | vices           |          | _             | ۔ <i>ا</i> ۔ | Date | •                |    |    |      |          |
| BKIMT                                |                 |          |               | 3/2          | - 0  | 7                |    |    |      |          |
| Reviewer NR program                  |                 |          |               | }            | Date | `                |    |    |      |          |


#### MARYLAND HISTORICAL TRUST NR-ELIBILITY REVIEW FORM

Camden Historic District (WI-552) Continuation Sheet No. 1

- The town's first development laws were enacted in 1892 and involved the Camden area. Only structures of brick, stone or iron with slate roofs or other non-combustible materials were permitted.
- Salisbury's first row homes were constructed in the area now known as Camden Court.
- The first planned residential development in Salisbury was centered around what is now North, South and Middle Boulevards in 1908.
- The 1909, L. W. Gunby, a resident of Camden, and Salisbury Auto Company opened the first automotive sales and service facility on Camden Avenue.
- In 1910, Frank W. Baysinger provided the City of Salisbury with its first taxi service from his garage on Camden Avenue.
- In 1890, the Jackson family constructed one of the most elegant homes built in the Camden area. This stylish example of
  architecture was beyond the scope of anything previously built in the City. Due to lack of regulations protecting such an
  architectural legacy, the home was demolished.
- The Newton Jackson home on the corner of Camden and Newton Street remains as a historic reminder of the City's past.
- The Gunby home at 507 Camden Avenue, built about 1830 and renovated in the 1880's, was the home of the founder of the William B. Tilghman Fertilizer Company.
- The Humphreys house located at 722 Camden Avenue was originally constructed between 1904 and 1906 and was once
  owned by Jesse D. Price, former member of the Maryland State Senate, who also served in the U.S. House of
  Representatives.
- The late Lee Johnson, a master mason and contractor, built one of the earliest examples of the innovative "Bungalow"
  Style of house located next to the Lutheran Church at South Boulevard. This example of a fine house was torn down because of a lack of control over the demolition of buildings in the area.
- On the northeast corner of Newton and Camden, a residence now used as an office by an accountant has been declared one
  of the oldest residences in Salisbury and shown on 1877 maps.
- The applicants have provided detailed documentation on the preliminary classification of ten historic structures in the area including such homes as "Red Gables" and "Humphreys House" to name only two.

| Prepared by: | Andrew Lewis | Date Prepared: 05/02/01 |
|--------------|--------------|-------------------------|
|              |              |                         |

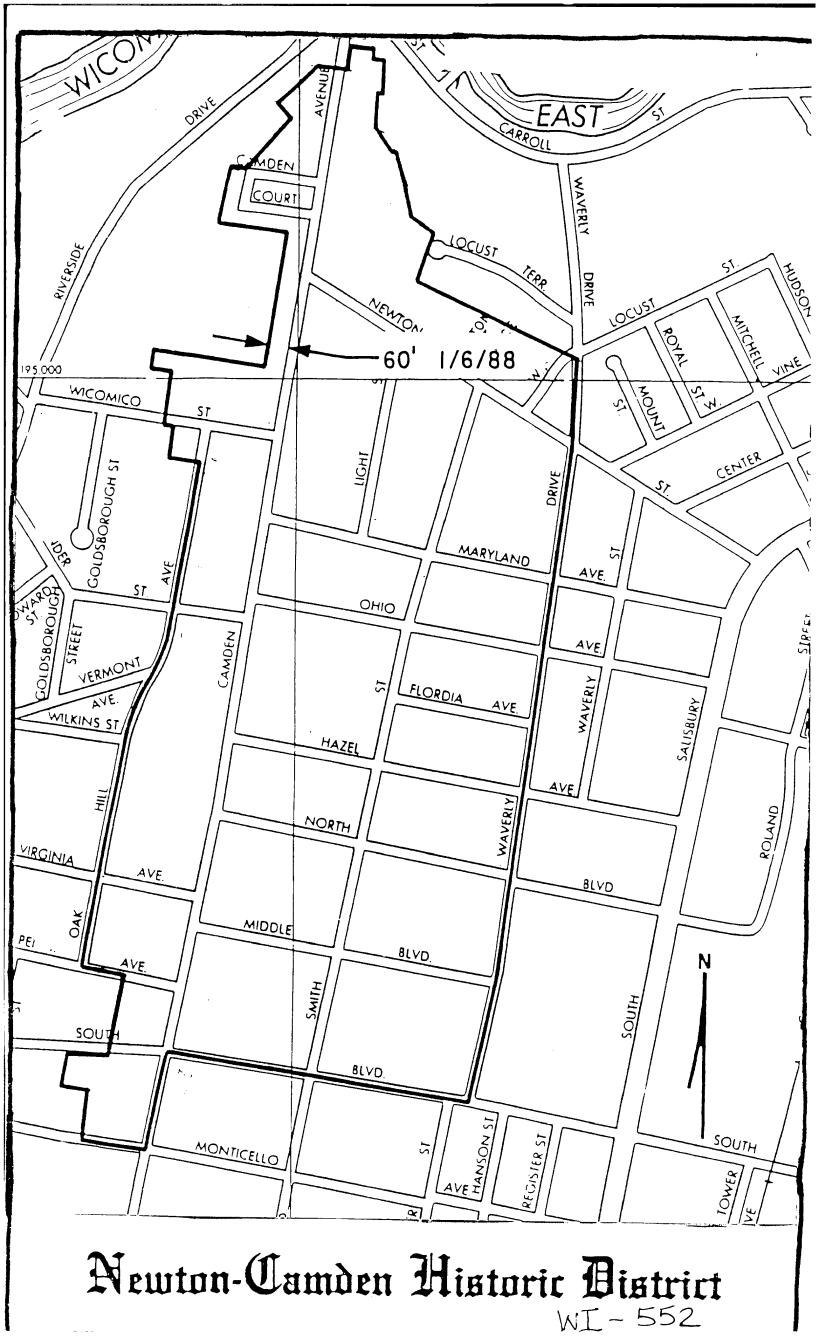

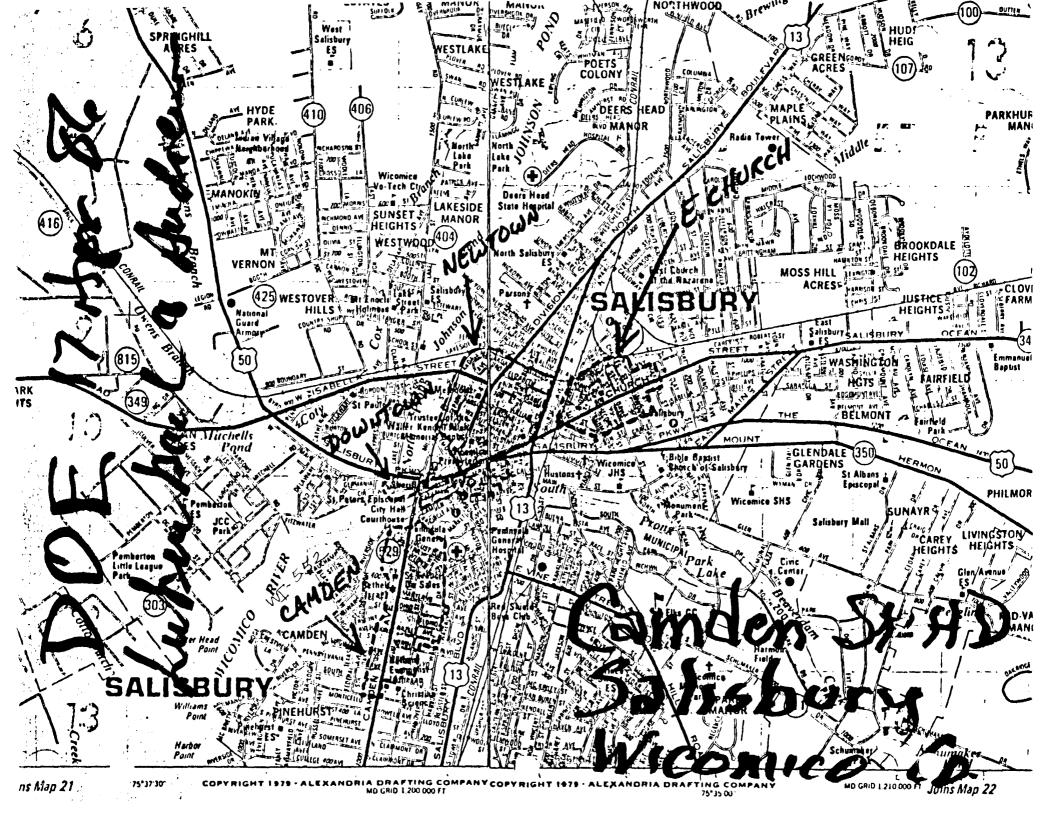

# MARYLAND HISTORICAL TRUST NR-ELIGIBILITY REVIEW FORM

NR Eligible: yes X no

| Property Name: Camden Historic District (aka Ne         | Inventory Number: WI-552   |
|---|--|
| Address: Cit  | y: Salisbury Zip Code:   |
| County: Wicomico  | USGS Topographic Map: Salisbury  |
| Owner:  |  |
| Tax Parcel #: Tax parcel Map Number:                    | Tax Account ID Number:   |
| Project:  | Agency:  |
| Site visit by MHT staff X no yes Nar                    | me: Andrew Lewis/ Date: 03/23/2001   |
| Eligibility recommended X Eligibility                   | not recommended  |
| Criteria: X A B X C D Considerations:                   | ABCDEFGNone  |
| Is the property located within a historic district? no  | yes Name of District:  |
| Is district listed? no yes District Is                  | nventory Number:   |
| Documentation on the property/district is presented in: |  |
|   |  |
|   |  |
| The Camden Historic District (aka the Newton-Camden Hi  | great deal of integrity and the earlier determination of ted within the district include Colonial Revival, Queen ecifically identifies some of the homes in the area to be of eclude "the Humphrey House, Red Gables and the house |
| Prepared by: C. Andrew Lewis                            | Date Prepared: 05/02/2001  |
| MARYLAND HISTORICAL TRUST REVIEW                        |  |
| Eligibility recommended X Eligibility no                | ot recommended   |
| Criteria X A B X C D Considerations                     | AB C D E F GNone   |
| MHT Comments:   |  |
| C. Andrew Lewis   | May 02, 2001   |
| Reviewer, Office of Preservation Services               | Date   |
| Peter Kurtze  | May 02, 2001   |
| Reviewer, NR Program                                    | Date   |

#### NR-ELIGIBILITY REVIEW FORM

-Camden Historic District (aka Newton)

Page 2

- 1. Camden Avenue was once the main highway connecting Salisbury with Princess Anne to the south crossing the 18th Century Mill Dam at Tony Tank and Allen. It continued through the heart of Salisbury running northward to the Delaware towns.
- 2. The Camden area was the location of the first known sanitary sewer installed in 1887 to serve the L.W. Gunby and William P. Jackson homes on Camden Avenue.
- 3 After the fire of 1886, City Board of Commissioners established a series of ordinances which included maintaining sidewalks in front of properties and establishing the rights of way of various streets. Among the first streets subject to improvement of widening and straightening in 1887 under this law was Camden Street, now Camden Avenue.
- 4 The town's first development laws were enacted in 1892 and involved the Camden area. Only structures of brick, stone or iron with slate roofs or other non-combustible materials were permitted.
- 5 Salisbury's first row homes were constructed in the area now known as Camden Court.
- 6 The first planned residential development in Salisbury was centered around what is now North, South and Middle Boulevards in 1908.
- 7 The 1909, L. W. Gunby, a resident of Camden, and Salisbury Auto Company opened the first automotive sales and service facility on Camden Avenue.
- 8 In 1910, Frank W. Baysinger provided the City of Salisbury with its first taxi service from his garage on Camden Avenue.
- 9 In 1890, the Jackson family constructed one of the most elegant homes built in the Camden area. This stylish example of architecture was beyond the scope of anything previously built in the City. Due to lack of regulations protecting such an architectural legacy, the home was demolished.
- 10 The Newton Jackson home on the corner of Camden and Newton Street remains as a historic reminder of the City's past.
- 11 The Gunby home at 507 Camden Avenue, built about 1830 and renovated in the 1880's, was the home of the founder of the William B. Tilghman Fertilizer Company.

| Prepared by:                                | C. Andrew Lewis                |  |              |        |       |     | Date Prepared: 05/02/2001 |         |     |     |      |  |
|---|--------------------------------|--|--------------|--------|-------|-----|---------------------------|---------|-----|-----|------|--|
| MARYLAND HIS                                |                                |  |              |        |       |     |                           |         |     |     |      |  |
| Eligibility recommended X Eligibility not r |                                |  |              | recomm | ended |     |                           |         |     |     |      |  |
| Criteria X A                                | ria X A B X C D Considerations |  |              | A _    | B     | _ C | _ D_                      | _ E     | _ F | _ G | None |  |
| MHT Comments:                               |                                |  |              |        |       |     |                           |         |     |     |      |  |
|   |                                |  |              |        |       |     |                           |         |     |     |      |  |
|   |                                |  |              |        |       |     | <b>N</b> f (              | 02 2004 |     |     |      |  |
| C. Andrew Lewis                             |                                |  | May 02, 2001 |        |       |     |                           |         |     |     |      |  |
| Reviewer, Office of Preservation Services   |                                |  | Date         |        |       |     |                           |         |     |     |      |  |
| Peter Kurtze                                |                                |  | May 02, 2001 |        |       |     |                           |         |     |     |      |  |
| Reviewer, NR Program                        |                                |  | Date         |        |       |     |                           |         |     |     |      |  |


#### NR-ELIGIBILITY REVIEW FORM

#### Camden Historic District (aka Newton)


#### Page 3

- 12 The Humphreys house located at 722 Camden Avenue was originally constructed between 1904 and 1906 and was once owned by Jesse D. Price, former member of the Maryland State Senate, who also served in the U.S. House of Representatives.
- 13 The late Lee Johnson, a master mason and contractor, built one of the earliest examples of the innovative "Bungalow" Style of house located next to the Lutheran Church at South Boulevard. This example of a fine house was torn down because of a lack of control over the demolition of buildings in the area.
- 14 On the northeast corner of Newton and Camden, a residence now used as an office by an accountant has been declared one of the oldest residences in Salisbury and shown on 1877 maps.
- 15 The applicants have provided detailed documentation on the preliminary classification of ten historic structures in the area including such homes as "Red Gables" and "Humphreys House" to name only two.

WI-552 Camden Historic District Salisbury, Md.

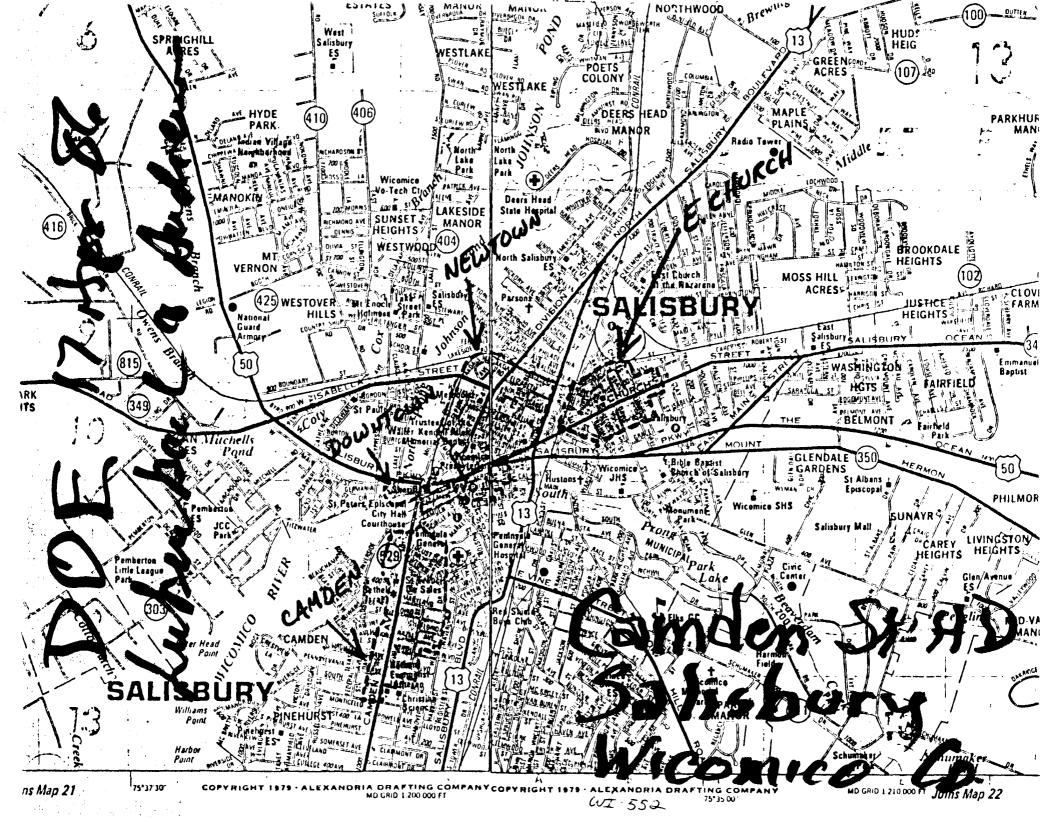

CAMPEN' HISTORIC DISTRICT (AKA NEWTON)
SALISBURY, WICCIMICC COUNTY, MD
WT. - 552

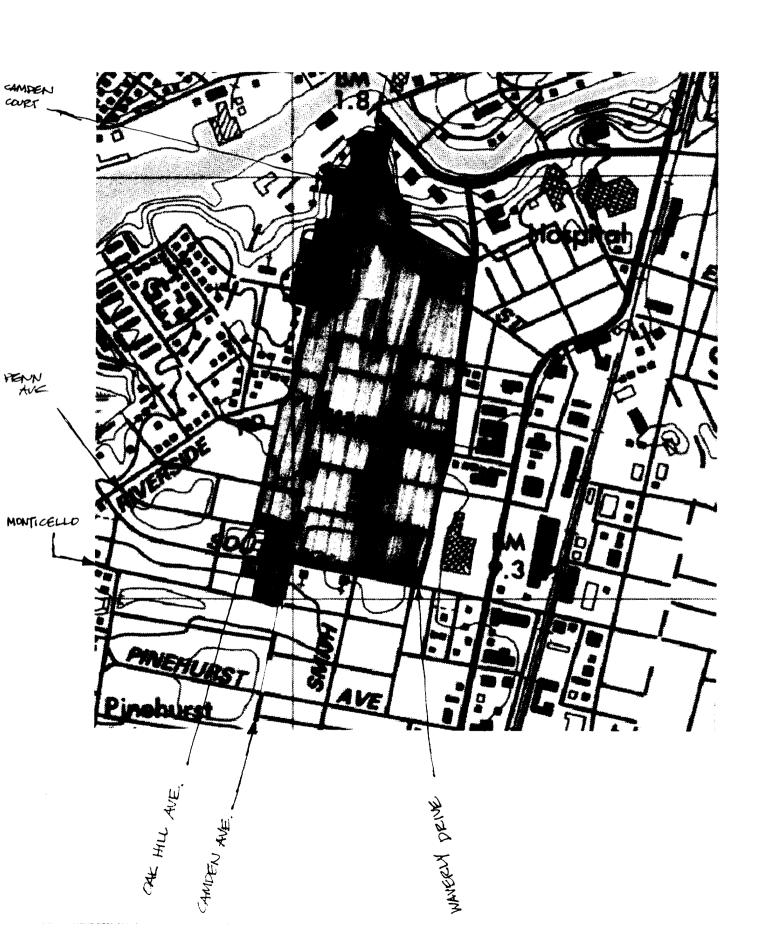

# Salisbury Historic District Commission

# **Hearing Notification**

July 26, 2023

**Hearing Date:** 

| Time:                            | 7:00 pm  |
|----------------------------------|--|
| Location:                        | Government Office Building<br>125 N. Division Street<br>Salisbury, MD. 21804<br>Room 301 |
| Case Number:                     | #23-18   |
| <b>Commission Considering:</b>   | Alterations  |
| Owner's Name:                    | REPC LLC   |
| Applicant Name:                  | Robert Cannon  |
| Agent/Contractor:                | Not Indicated  |
| <b>Subject Property Address:</b> | 226 Newton St.   |
| Historic District:               | Camden Historic District   |
| Use Category:                    | Residential  |
| Chairman:                        | Mr. Scott Saxman   |
| HDC Staff contact:               | Jessica Budd<br>Associate Planner I<br>(410) 548-3170                                    |

# Salisbury Historic District Commission

125 N. Division Street Room 202 Salisbury, MD 21801 (410) 548-3170/ fax (410) 548-3107 Permit Application

Received 1/7/23(date)


Secretary, S.H.D.C. (Date)


| Date Submitted: 7/7/23   | 4 22 18   |
|--|---|
| Date Accepted as Complete: 7/7/23  | Case #: # 23-18 Action Required By (45 days): 8/20/23 |
| Subject Location: 226 NEWTON STREET  |   |
| Application by: ROBERT CANNON  | Owner Name: RER AND HTC LLC                           |
| Applicant Address: 106 CJRCLE AVE, SALJSBVRY MD 21801  | Owner Address: C/O ROBERT CANNON, 106 CARD            |
| Applicant Phone: 4/0-749-5/19  | Owner Phone: 410-749-5179                             |
| Applicant Flione. 7/0 /4/-9/1/   | Owner Email: CANNON LPM & CONCAST. NE,                |
| Work Involves:New Construction   | onAddition Other                                      |
| Demolition Sign  | Awning Estimated Cost 201                             |
| <b>DESCRIPTION OF WORK PROPOSED</b> (Please be specific  | Attach sheet if space is inadequate) Type of          |
| material, color, dimensions, etc. must accompany application   | 1. It signs are proposed indicate material            |
| metriod of attachment, position on building, size and front line   | eal feet of building, size and position of all        |
| other signs on building, and a layout of the sign.   |   |
| SEE ATTACHER   |   |
|  |   |
|  |   |
| Ave there are  |   |
| Are there any easements or deed restrictions for the extended from the easement holder stations their arms of the  | erior of this property? If yes, submit a              |
| letter from the easement holder stating their approval of  | the proposed workYes_V_No                             |
| Do you intend to apply for Federal or State Rehabilitation   | Tay Credite? If you have you contacted                |
| maryland riistorical Frust Staff? Yes 1/ No  |   |
| If you have checked "Yes" to either of the above question  | ons, please provide a copy of your approval           |
| letter from the Maryland Historic Trust a  | along with this application.                          |
|  |   |
| See Reverse Side for DOCUMENTS REQUIRED  | TO BE FILED WITH APPLICATION                          |
| All required documents must be submitted to the City Planner, Depleast 30 days prior to the payt public mosting. Failure to include all  | partment of Infrastructure and Development at         |
| least 30 days prior to the next public meeting. Failure to include all applicant or his/her authorized representative to appear at the school application until the post regular asked delegate. | the required attachments and/or failure of the        |
| application until the next regular scheduled meeting. It an applicati  | On is denied the same application connet be           |
| resubilitied for one year from date of such action. Please be advis  | sed that members of the Salisbury Historic District   |
| commission of stan, may visit the subject property prior to the sch  | eduled meeting date to familiarize themselves with    |
| the project.   |   |
| The Salisbury Historic District Commission Rules and Regulations   | and Dagin Cuidalines are suitable for                 |
| the office of the Department of Infrastructure and Development for   | the City of Salisbury as well as an the City of       |
| website: www.ci.salisbury.md.us.   | the Oity of Galisbury as well as off the City's       |
|  |   |
| l, or my authorized representative, will appear at the meeting of the on(date).  | e Salisbury Historic District Commission              |
| on(date).  |   |
| hereby certify that the owner of the subject premises has been ful   | ly informed of the alterations herein proposed and    |
| illat said owner is in full agreement with this proposal.  | , which is the anormal noton proposed and             |
| Applicant's  | 1 22 22   |
| Signature M M  | Date 6-27-23  |
| 1/23 Ble 7/1/23  | Brian Soper 7/18/23                                   |
| pplication Processor (Date)  | Secretary, S.H.D.C. (Date)                            |


## **226 Newton Street**


## Proposed renovation plans:


- 1. Install vinyl siding on the exterior of the house to match as close as possible the old clapboard and clamshell siding that is presently underneath the asbestos shingles;
- 2. Replace the windows with vinyl replacement windows with similar grills. It should be noted that some of the current windows are very large and dangerous in that the bottoms of the windows are only 19 inches above the floor. We intend to replace them with windows that meet the current code compliant size and height requirements;
- 3. Wrap the exterior widow trim and boxing in metal;
- 4. Replace roofs with architectural asphalt shingles;
- 5. Install gable vents for proper ventilation of the attic in place of the gable windows;
- 6. Rebuild two-thirds of the kitchen at the rear of the house (the roof of which has collapsed) to similar dimensions;
- 7. Install a code-compliant exit stairway at the rear of the house for a second required exit for the current second floor unit;
- 8. Install new exterior metal doors; and
- 9. Install a new front porch deck with similar tongue and groove vinyl decking boards and replace the posts and bannisters with similar size and shape plastic or vinyl.

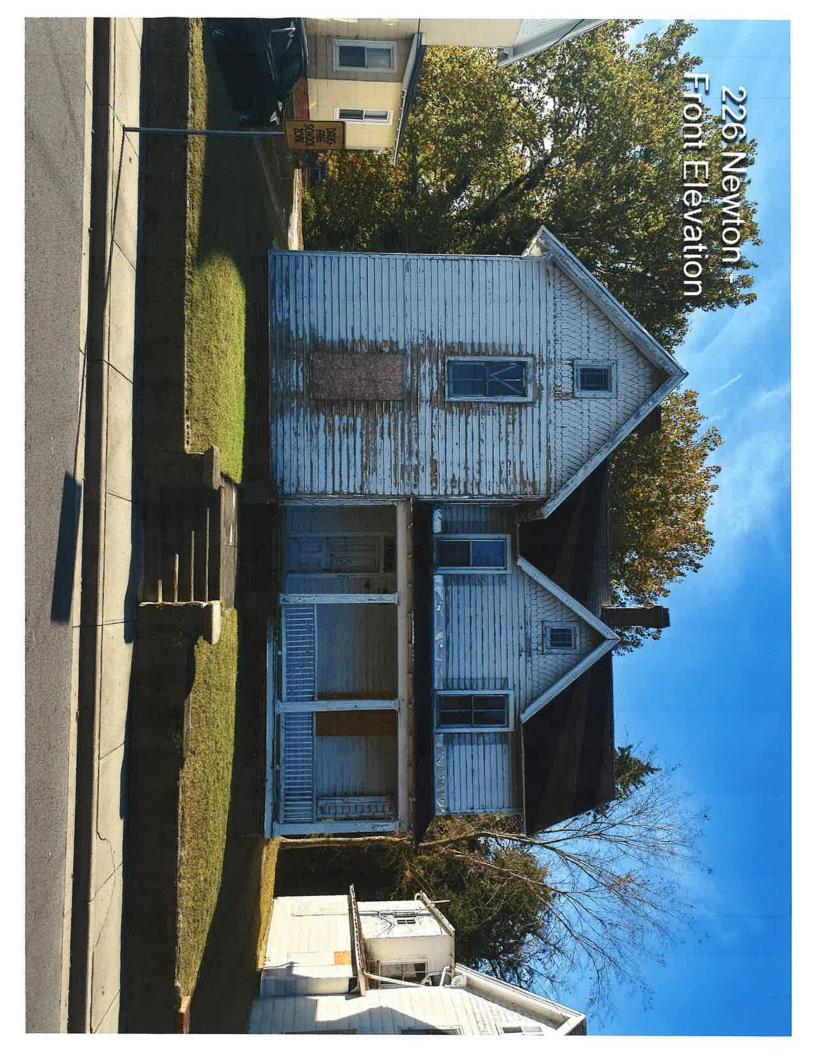


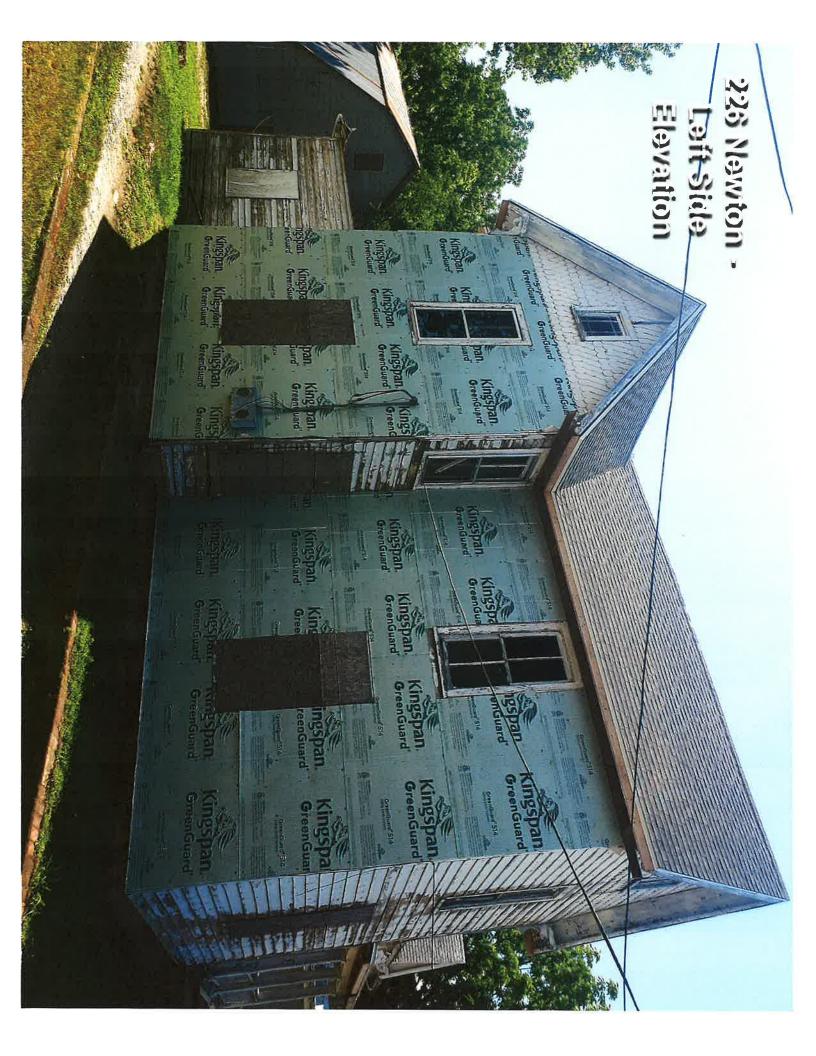


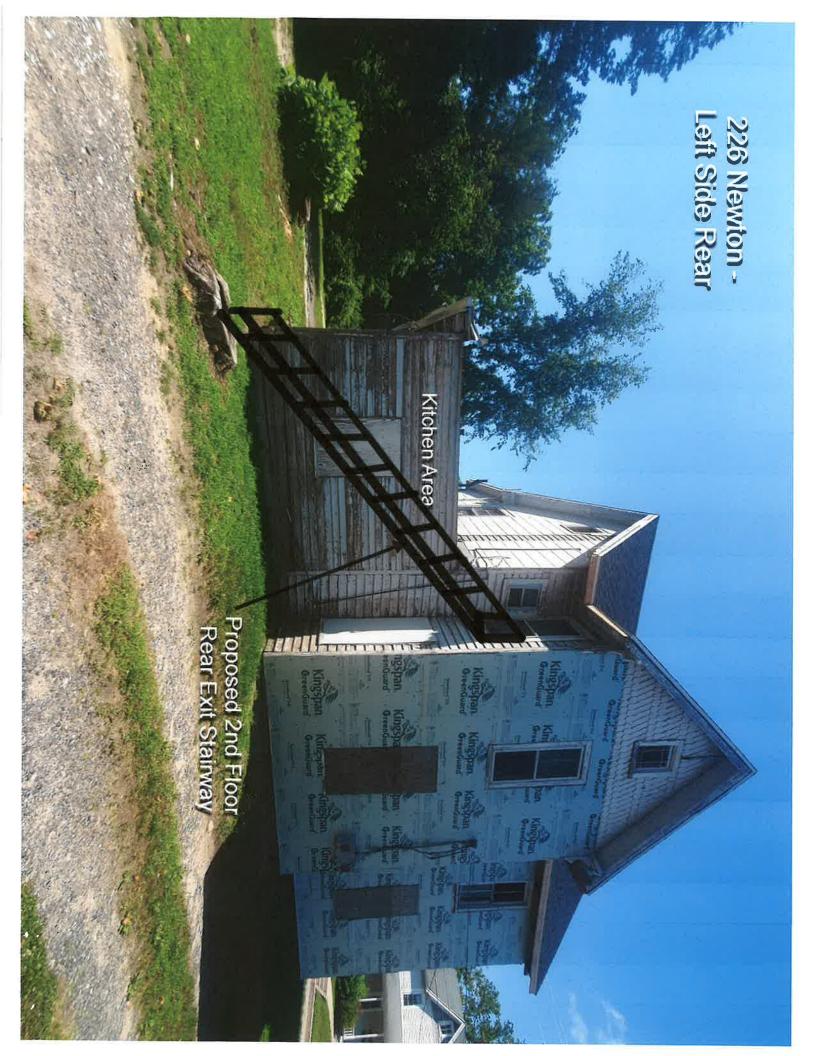

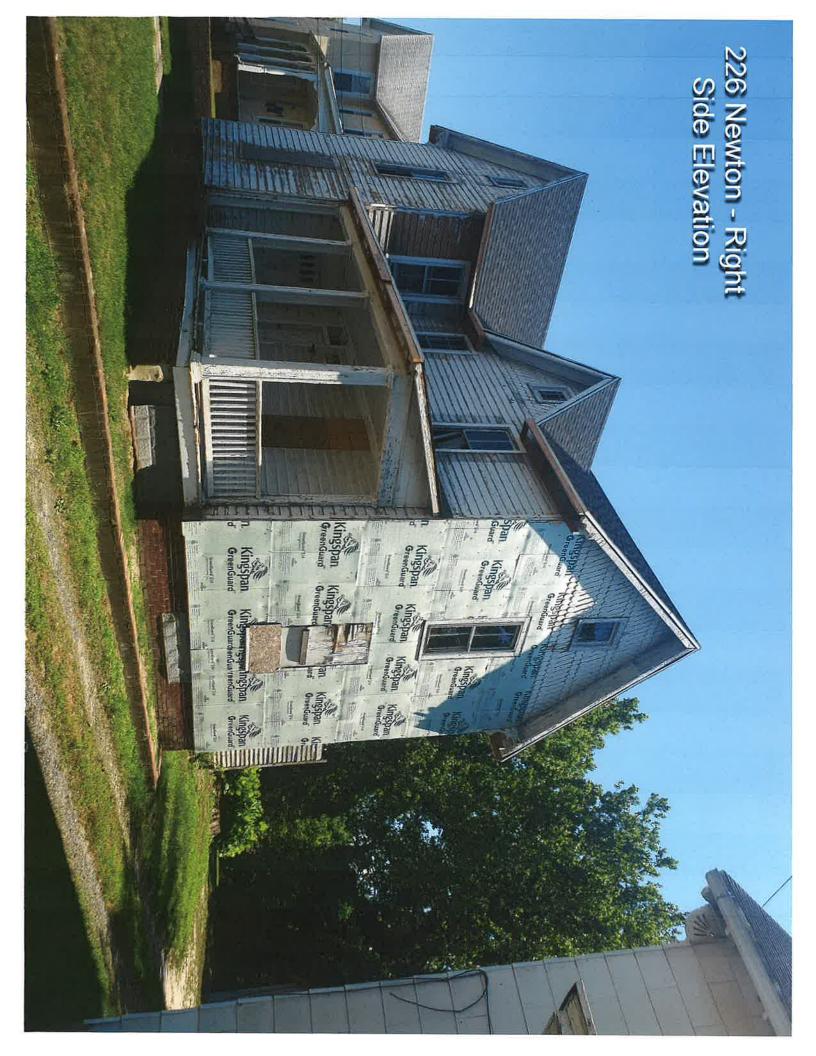

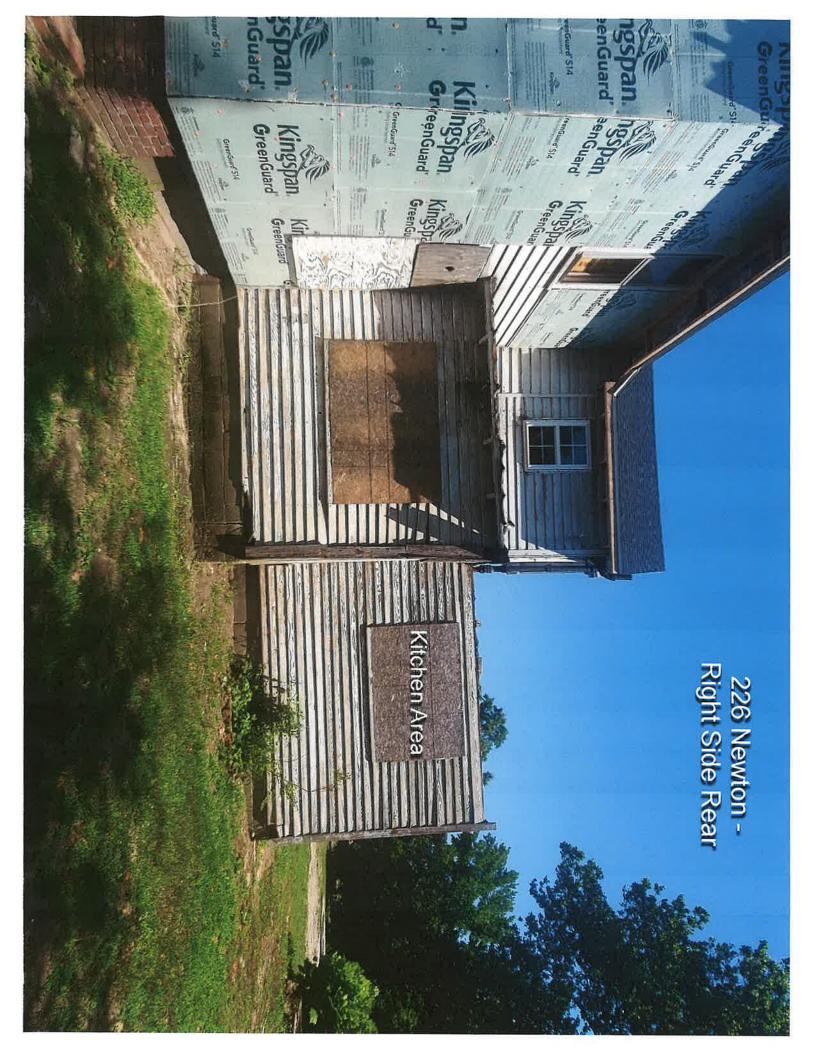


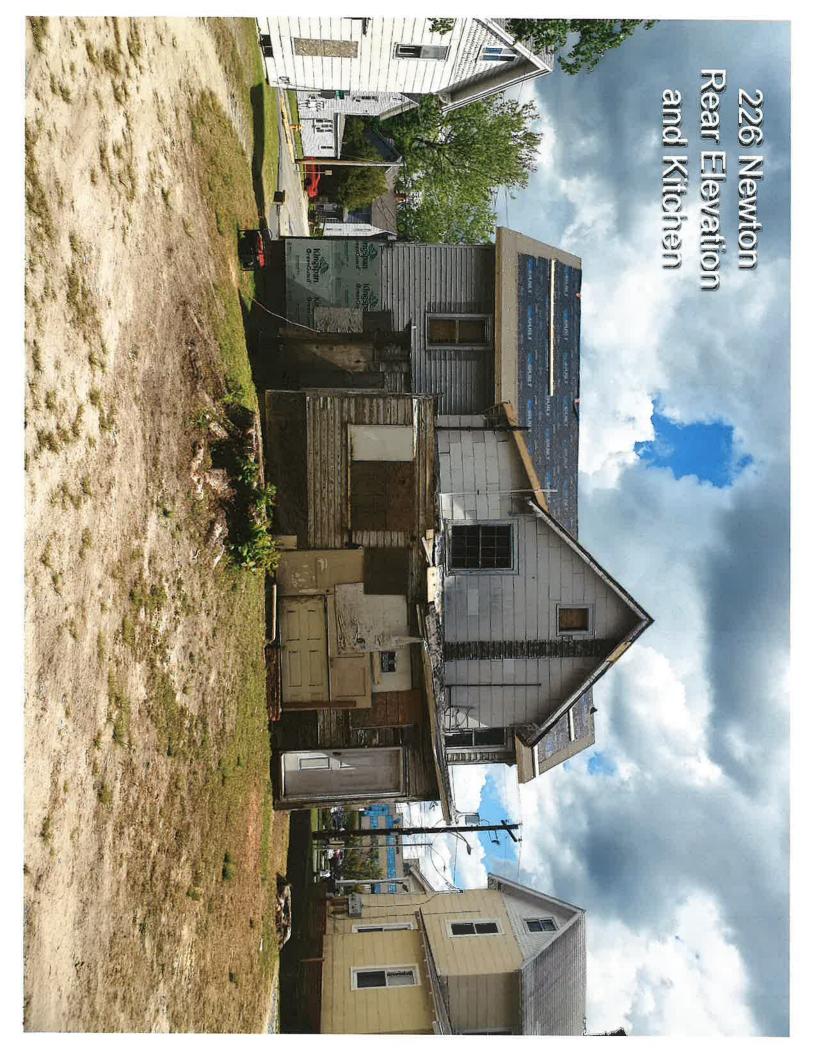


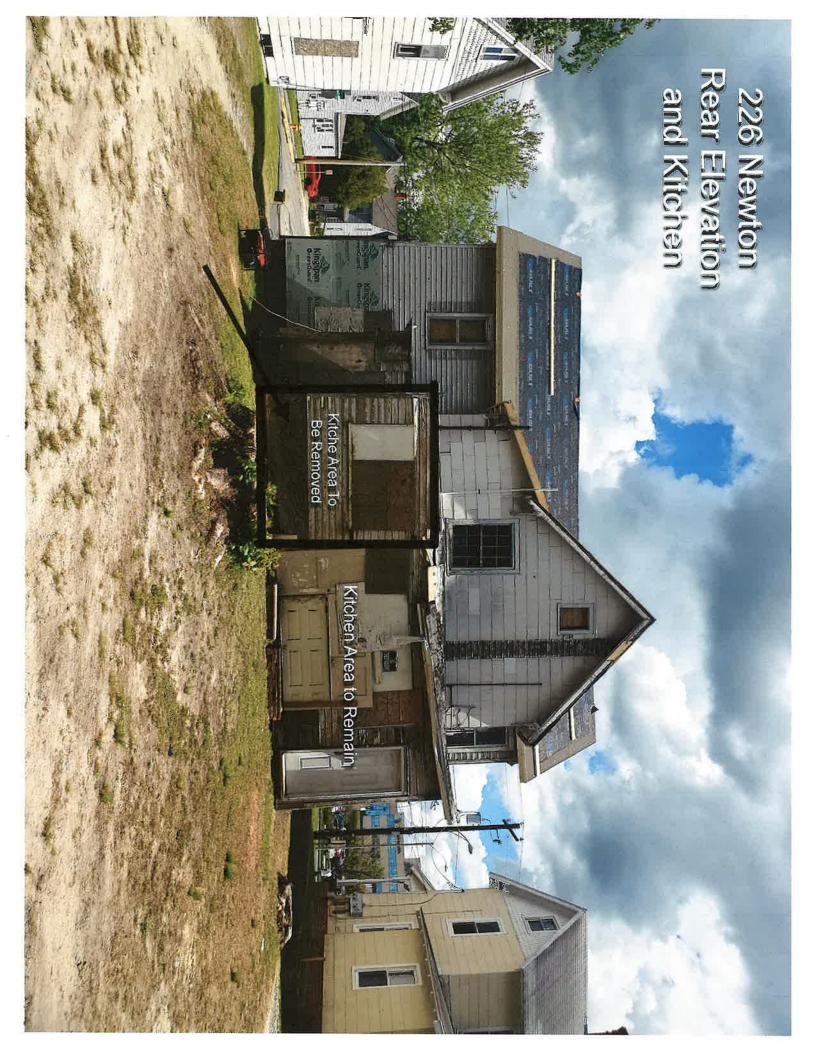






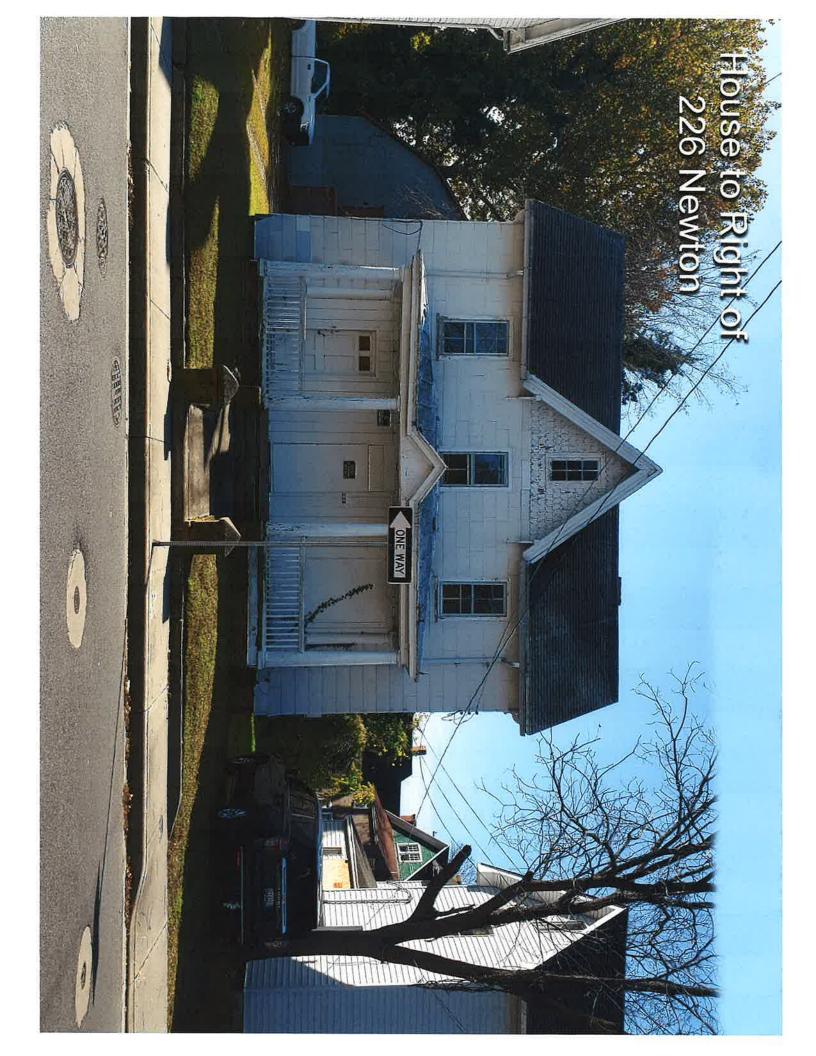

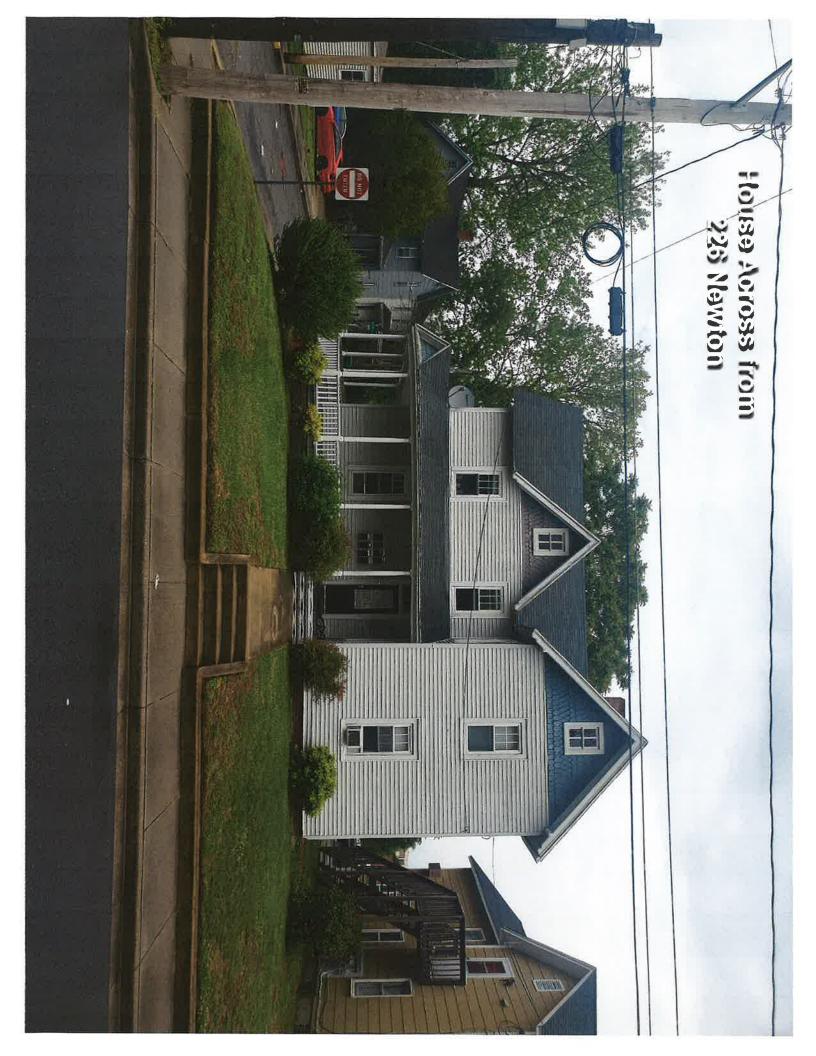



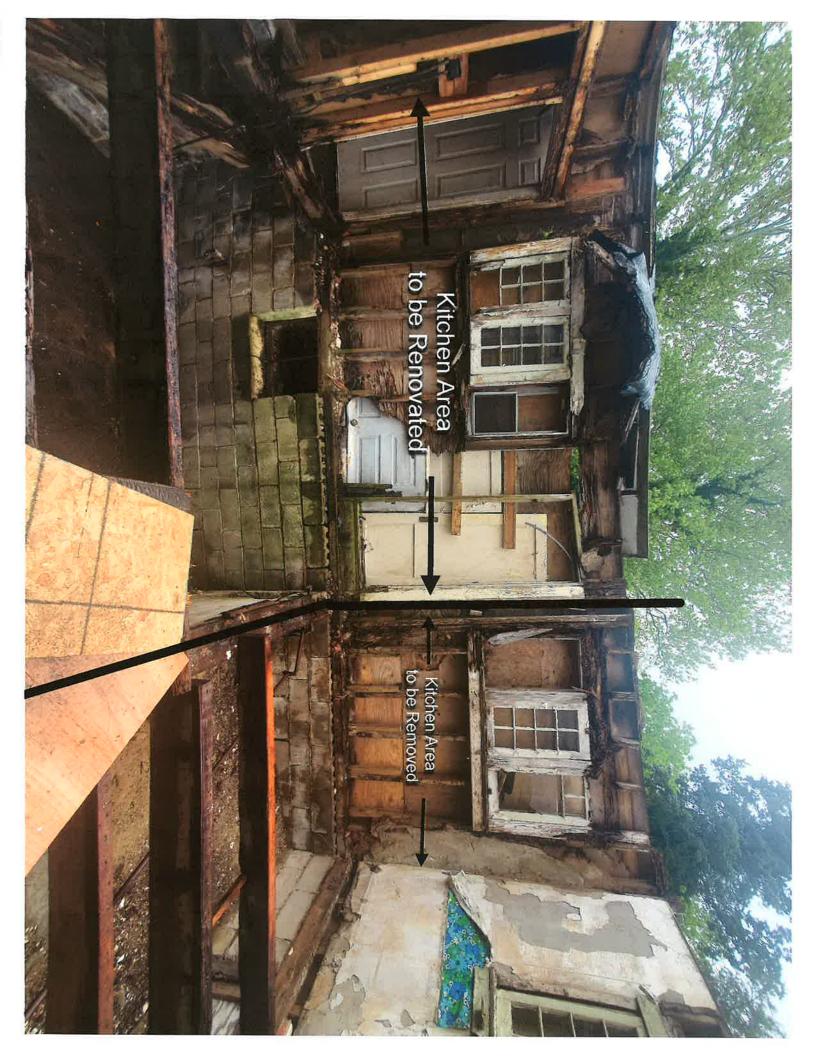

226 Newton Existing
Size Size

Vindow Sills WobniW 19" From Floor

# Viwinco Dealer Quote

# BEACON BUILDING PRODUCTS 505 MARVEL RD SALISBURY, MD 21801

| 4 1 | Quote Number:           | Ų |
|-----|-------------------------|---|
|     | 00315013                |   |
|     | Job Name:               |   |
|     | Will Chavez             |   |
|     | Quote Date: May 9, 2022 |   |
|     |                         | _ |

Sold To: 50158620

Ship To:

505 Marvel Road Salisbury, MD 21801

505 Marvel Road Salisbury, MD 21801

| Line # Ordered | Order Specifications |
|----------------|----------------------|
|----------------|----------------------|

0001

6

**S-Series Double Hung** 

Viewed from Exterior

APPLICATION: NEW CONSTRUCTION (NON-IMPACT)

**MEASURE CODE: ROUGH OPENING** 

WIDTH: 28.7500 HEIGHT: 67.0000

LAYOUT: EQUAL LITE

COLOR: WHITE EXTERIOR / WHITE INTERIOR GLASS PACKAGE: STANDARD GLASS PACKAGE GLASS COLOR OPTIONS: CLEAR / LOW-E

**GRID TYPE: NONE** 

SCREEN: EXTRUDED HALF SCREEN

SCREEN MESH: BVUE\_V SCREEN SHIP: IN WINDOW

LOCK AND KEEPER FINISH: WHITE FINISH

HARDWARE: THIS WINDOW DOES NOT MEET EGRESS

Performance: SHGC: 0.20, U-Factor: 0.29, VT: 0.46, CPD: VWN-K-10-00638-00001

DP Value: 50

Florida Approval: 17528.1

Date Printed: 5/16/2023 02:06 PM
Created By: davidm@roofcenter.com
Page 1 of 4 00315013


Oty Line# **Order Specifications** Ordered

0002

4

**S-Series Double Hung** 

Viewed from Exterior

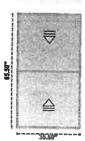

APPLICATION: NEW CONSTRUCTION (NON-IMPACT)

MEASURE CODE: ROUGH OPENING

WIDTH: 36.0000 **HEIGHT: 66,0000 LAYOUT: EQUAL LITE** 

COLOR: WHITE EXTERIOR / WHITE INTERIOR GLASS PACKAGE: STANDARD GLASS PACKAGE

GLASS COLOR OPTIONS: CLEAR / LOW-E

**GRID TYPE: NONE** 

SCREEN: EXTRUDED HALF SCREEN

SCREEN MESH: BVUE V SCREEN SHIP: IN WINDOW

LOCK AND KEEPER FINISH: WHITE FINISH

HARDWARE: THIS WINDOW MEETS EGRESS, EGRESS HARDWARE IS INSTALLED

Performance: SHGC: 0.20, U-Factor: 0.29, VT: 0.46, CPD: VWN-K-10-00638-00001

DP Value: 50

Florida Approval: 17528.1

0003

6

**S-Series Double Hung** 



38 3E

Viewed from Exterior

APPLICATION: NEW CONSTRUCTION (NON-IMPACT)

MEASURE CODE: ROUGH OPENING

WIDTH: 28.7500 **HEIGHT: 56.7500 LAYOUT: EQUAL LITE** 

**COLOR:** WHITE EXTERIOR / WHITE INTERIOR GLASS PACKAGE: STANDARD GLASS PACKAGE GLASS COLOR OPTIONS: CLEAR / LOW-E

**GRID TYPE: NONE** 

SCREEN: EXTRUDED HALF SCREEN

**SCREEN MESH: BVUE V** SCREEN SHIP: IN WINDOW

LOCK AND KEEPER FINISH: WHITE FINISH

HARDWARE: THIS WINDOW DOES NOT MEET EGRESS

Performance: SHGC: 0.20, U-Factor: 0.29, VT: 0.46, CPD: VWN-K-10-00638-00001

DP Value: 50

Florida Approval: 17528.1

Date Printed: 5/16/2023 02:06 PM Created By: davidm@roofcenter.com

Page 2 of 4


00315013

Qtv Line# **Order Specifications** Ordered 1

0004

S-Series Double Hung

#### Viewed from Exterior

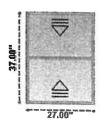

APPLICATION: NEW CONSTRUCTION (NON-IMPACT)

**MEASURE CODE: ROUGH OPENING** 

WIDTH: 27.5000 **HEIGHT: 37.5000** LAYOUT: EQUAL LITE

**COLOR:** WHITE EXTERIOR / WHITE INTERIOR GLASS PACKAGE: STANDARD GLASS PACKAGE GLASS COLOR OPTIONS: CLEAR / LOW-E

**GRID TYPE: NONE** 

SCREEN: EXTRUDED HALF SCREEN

SCREEN MESH: BVUE V SCREEN SHIP: IN WINDOW

LOCK AND KEEPER FINISH: WHITE FINISH

HARDWARE: THIS WINDOW DOES NOT MEET EGRESS

Performance: SHGC: 0.20, U-Factor: 0.29, VT: 0.46, CPD: VWN-K-10-00638-00001

DP Value: 50


Florida Approval: 17528.1

0005

1

## S-Series Double Hung

Viewed from Exterior

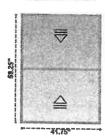

APPLICATION: NEW CONSTRUCTION (NON-IMPACT)

MEASURE CODE: ROUGH OPENING

WIDTH: 42.2500 **HEIGHT:** 58.7500 **LAYOUT: EQUAL LITE** 

**COLOR:** WHITE EXTERIOR / WHITE INTERIOR GLASS PACKAGE: STANDARD GLASS PACKAGE GLASS COLOR OPTIONS: CLEAR / LOW-E

GRID TYPE: NONE

SCREEN: EXTRUDED HALF SCREEN

SCREEN MESH: BVUE\_V **SCREEN SHIP: IN WINDOW** 

LOCK AND KEEPER FINISH: WHITE FINISH

HARDWARE: DOUBLE LOCKS / THIS WINDOW MEETS EGRESS, EGRESS HARDWARE

IS INSTALLED

Performance: SHGC: 0.20, U-Factor: 0.29, VT: 0.46, CPD: VWN-K-10-00638-00001

DP Value: 50

Florida Approval: 17528.1

0006

ed from Externo

S-Series Mulled Units 3U-1R3C

CONFIG: 3U-1R3C APPLICATION: NEW CONSTRUCTION (NON-IMPACT)

MEASURE CODE: ROUGH OPENING

OVERALL WIDTH: 63,0000 **OVERALL HEIGHT: 36.5000** 

**CUSTOM SIZES: NO** 

**COLOR:** WHITE EXTERIOR / WHITE INTERIOR GLASS PACKAGE: STANDARD GLASS PACKAGE

**UNIT 01: S-Series Double Hung** 

WIDTH: 20.5000 **HEIGHT: 36.0000** 

Date Printed: 5/16/2023 02:06 PM Created By: davidm@roofcenter.com Page 3 of 4

20.50

00315013

| Line#     | Qty<br>Ordered   | Order Specifications   |
|-----------|------------------|--|
|           |                  | LAYOUT: EQUAL LITE   |
|           |                  | COLOR: WHITE EXTERIOR / WHITE INTERIOR   |
|           |                  | GLASS PACKAGE: STANDARD GLASS PACKAGE  |
|           |                  | GLASS COLOR OPTIONS: CLEAR / LOW-E   |
|           |                  | GRID TYPE: NONE  |
|           |                  | SCREEN: EXTRUDED HALF SCREEN   |
|           |                  | SCREEN MESH: BVUE_V  |
|           |                  | SCREEN SHIP: IN WINDOW   |
|           |                  | LOCK AND KEEPER FINISH: WHITE FINISH   |
|           |                  | HARDWARE: THIS WINDOW DOES NOT MEET EGRESS   |
|           |                  | UNIT 02: S-Series Double Hung  |
|           |                  | WIDTH: 20.5000   |
|           |                  | HEIGHT: 36.0000  |
|           |                  | LAYOUT: EQUAL LITE   |
|           |                  | COLOR: WHITE EXTERIOR / WHITE INTERIOR   |
|           |                  | GLASS PACKAGE: STANDARD GLASS PACKAGE  |
|           |                  | GLASS COLOR OPTIONS: CLEAR / LOW-E   |
|           |                  | GRID TYPE: NONE  |
|           |                  | SCREEN: EXTRUDED HALF SCREEN SCREEN MESH: BVUE V                                       |
|           |                  | SCREEN MESH: BVUE V<br>SCREEN SHIP: IN WINDOW  |
|           |                  | LOCK AND KEEPER FINISH: WHITE FINISH   |
|           |                  | HARDWARE: THIS WINDOW DOES NOT MEET EGRESS   |
|           |                  | UNIT 03: S-Series Double Hung  |
|           |                  | WIDTH: 20.5000   |
|           |                  | <b>HEIGHT:</b> 36.0000   |
|           |                  | LAYOUT: EQUAL LITE   |
|           |                  | COLOR: WHITE EXTERIOR / WHITE INTERIOR   |
|           |                  | GLASS PACKAGE: STANDARD GLASS PACKAGE  |
|           |                  | GLASS COLOR OPTIONS: CLEAR / LOW-E   |
|           |                  | GRID TYPE: NONE  |
|           |                  | SCREEN: EXTRUDED HALF SCREEN   |
|           |                  | SCREEN MESH: BVUE_V<br>SCREEN SHIP: IN WINDOW  |
|           |                  | LOCK AND KEEPER FINISH: WHITE FINISH   |
|           |                  | HARDWARE: THIS WINDOW DOES NOT MEET EGRESS   |
|           |                  |  |
|           |                  | Performance (All Units): SHGC: 0.20, U-Factor: 0.29, VT: 0.46, CPD: VWN-K-10-00638-000 |
|           |                  | DP Value: 50   |
|           |                  | Florida Approval (All Units): 17528.1  |
|           |                  |  |
| ate Print | ed: 5/16/2023 02 | ·06 PM   |
|           | davidm@roof      |  |

We ask that you thoroughly review the quote for accuracy, before ordering the product. By responding to this email, or signing the quote, you authorize us to order the product/special order product and you agree all quantities, sizes, and specifications are correct. No changes or cancellations can occur once special order items have been submitted to the manufacturer.

THIS ESTIMATE IS VALID FOR 30 DAYS. SPECIAL ORDER ITEMS CANNOT BE RETURNED.

| Customer Signature: | Date: |
|---------------------|-------|
|                     |       |

# Salisbury Historic District Commission

# **STAFF FINDINGS**

# Meeting of July 26, 2023

Case Number: #23-18

**Commission Considering:** Alterations

Owner Name: REPC LLC
Owners Address: 106 Circle Ave

Salisbury, MD 21801

Applicant Name: Robert Cannon

**Applicant's Address:** 106 Circle Ave

Salisbury, MD 21801

Agent/Contractor: TBD

**Subject Property Address:** 226 Newton St

**Historic District:** Camden Historic District

Use Category: Residential

**Zoning Classification:** R-8

**Structure / Site Description:** 

Built Date: 1915

**Enclosed Area:** 2,370 sq. ft.

**Lot Size:** 9,000 sq. ft.

**Number of Stories:** 2

Contributing Structure: TBD

**Wicomico County Historic Survey on file:** No

**Nearby Properties on County Survey:** Yes

# **Including but not limited to:**

232 Newton St- William Mitchell House

# **Explanation of Request:** The applicant is seeking approval to repair the following:

- Install Vinyl Siding
- Replace windows with vinyl, and wrap window trim
- Replace the roof with architectural asphalt shingles
- Install gable vents for proper ventilation of the attic in place of gable windows
- Rebuild two-thirds of the kitchen at the rear of the house to similar dimensions
- Install an exit stairwell in rear for second floor unit
- Install new exterior metal doors
- Install new front porch deck. With similar tongue and groove vinyl decking boards and replace post and banisters with similar size and shape plastic or vinyl

## Areas of Historic Guidelines to be considered:

## Guideline 13: Match Existing or Historic Siding

- a. Where full-scale siding replacement is necessary, match the historic or existing siding on the building. Keep the details (width of wood boards, shingle size, corner and seam details, etc.) consistent with the historic appearance.
- b. When replacing non-historic siding that was inappropriately applied, chose an appropriate replacement that is consistent with buildings of the type, period, and architectural style.
- c. Do not cover historically uncovered masonry surfaces with siding. Siding applied to masonry surfaces has the potential to hold moisture and cause damage to the underlying wall.

### **Guideline 14:** Synthetic Siding

Synthetic siding describes a siding product not made from natural materials. Vinyl, asphalt, and fiber cement board are the most commonly found synthetic siding types.

- a. The use of new synthetic siding may be approved on a case by case basis if one or more of the following conditions are met.
- b. Historic decorative details should not be removed or covered by synthetic siding. These details include but are not limited to cornices, window hoods, moldings, eaves, decorative shingles, and trim.
- c. Synthetic siding may not be applied over historically uncovered masonry walls.

## **Guideline 17:** Retain Historic Windows

a. Maintain or restore the historic shape, size, alignment, pattern, and details of existing historic windows, particularly those in upper stories of commercial properties. (For guidelines on

storefront windows, see the Storefronts Guidelines in the following section).

- b. Do not infill window openings or cover existing historic windows.
- c. Consider reopening windows that are presently blocked, if your budget allows.

# Guideline 18: New Window Openings and Infill

Altering window openings in historic facades alters the building's historic appearance significantly, and is typically not appropriate, but may be considered in some situations.

- a. Avoid placing new openings on the front facade.
- b. If new openings are required for additional light, consider placing them on the rear or side elevations of the building or installing a skylight on a non-visible roof slope.
- c. Avoid infilling existing window openings on the front facade.
- d. Where recent changes have altered historic window openings, restoration of the historic configuration and materials is encouraged.

## **Guideline 24:** Roofing Material

In-kind replacement of roofing materials is always preferable to replacement with a new material, however, this is not always feasible. Standing seam metal in copper, tin, or terne coated steel are traditional materials which can be replaced with new versions provided that they are flat and of a uniform color and texture. Asphalt, asphalt shingles, and mineral fiber slate may be appropriate substitutes for many traditional materials.

- a. Retain and repair the historic roof material when feasible.
- b. Where replacement is necessary, match the historic materials as closely as possible in terms of material, size, color, and pattern.
- c. Requests for substitute roofing materials will be reviewed on a case-by-case basis.
- d. When asphalt shingles are used to replace wood or slate, heavy weight architectural shingles which provide depth and variation, and which match the shape of the historic materials, are preferred.
- e. Roofing materials on additions should match or mimic the material on the main body of the historic building.
- f. Roofing materials on new construction should be consistent with the prevalent roofing material on surrounding buildings.
- g. Repair of isolated sections of a roof must match the existing tiles in material composition, style, size and color.

## **Guideline 28:** Chimneys and Vents

- a. Maintain existing chimneys. When repairs are necessary, match the existing materials, colors, shape, brick pattern, and details as closely as possible.
- b. Avoid changing the height, massing, or scale of existing chimneys.
- c. New vents should be placed in a location which is not visible from the public right of way.
- d. New chimneys on new construction should be consistent with the height, massing, and proportions of chimneys found in the surrounding area.

# Guideline 35: Additions

Although it is not impossible to add a story or more to historic buildings, it is normally more difficult to avoid adverse impact to the building's original design, character, and detailing.

- a. Consider the issue of structural strength and ability to carry another floor. This issue should be addressed by a qualified structural engineer.
- b. Whenever possible, an addition should be placed at the rear of the main building.
- c. Additions should be constructed in materials compatible with those used in the original building. This does not mean that the same materials have to be used.
- d. Frame additions can be added to brick and stucco buildings successfully.
- e. Additions should not duplicate the architecture and design of the main building but should pick up overall design "cues" from the main building, such as window proportions, overall massing and form, and type of ornamentation.
- f. Avoid changes that obscure, damage or destroy significant characteristic features of an existing building or historic district.
- g. New additions should be compatible with existing historic buildings in terms of scale, but should be visually different from the original to avoid creating a false historic appearance. Additions to historic structures should be identifiable as a new addition to an original building. h. New additions should be subordinate to the main building. This can be achieved by making the addition smaller in scale than the main building, or by keeping the roofline or parapet below that of the main building.

## **Guideline 53:** Replacing Residential Doors

- a. Where replacement is necessary, the new door should match the historic door in placement, size, type, and configuration wherever possible.
- b. When restoring missing historic doors, use pictorial evidence to produce the replacements, if your budget allows. A salvaged replacement in the same style that fits the opening, or a new door in a complimentary style are also appropriate choices.
- c. If replacement with a new door is unavoidable, chose one that mimics the size, scale, design, and texture of an appropriate historic door. Proportions and details should be in keeping with the building's architectural style.
- d. Maintain the historic door opening size and surrounding trim, including side lights and transoms. Do not alter the size of the opening to fit a smaller or larger door, unless required by code.

## Guideline 54: Storm and Screen Doors

- a. Select a storm or screen door in a style typical of the period or style in which your building was constructed.
- b. Wood storm and screen doors are typically the most appropriate, however, metal doors with a baked enamel finish in an appropriate style may also be approved.
- c. The color should match the existing door sash or trim.

## **Guideline 55:** Restore Historic Porch Features

- a. Maintain the historic porch or stoop when feasible. Keep wooden surfaces painted and keep up with general maintenance.
- b. If repair or rehabilitation is necessary, keep as much of the historic materials in place as possible. Maintain the porch's design, proportion, and ornament to the greatest extent possible.
- c. Replace missing porch posts and railings where necessary. Match the size, shape, profile, proportion, and spacing to the original features.
- d. Use of synthetic replacement materials may be allowed if the new material closely approximates the size, scale, texture, and overall appearance of the historic feature.

# **Guideline 56:** Replacement Porches

- a. If porch replacement is necessary in whole or in part, reconstruct it to match the historic porch in size, scale, and overall design. Where possible, detail and ornamentation should be replicated.
- b. Use the same or similar materials wherever feasible.
- c. Avoid applying decorative elements that are not appropriate to the style of the dwelling. Whenever possible, choose accurate details based on historic photographs or similar properties of the same period and style.

## **Evaluation Criteria:**

Pursuant to Section 17.52.040 A & B of the Salisbury Zoning Code, it is the duty of the Historic District Commission to review all applications to construct, alter, reconstruct, move or demolish any structure within a Historic District whenever the exterior appearance of such structure is affected, and to approve or reject said application. In reviewing an application and plans, the Commission should give consideration to review criteria, and may make a determination as to which of said Criteria are applicable.

Staff Findings Prepared By: Jessica Budd Infrastructure and Development 125 N Division Street, Suite 202 Salisbury, MD 21801 (410) 548-3170 Date: July 17, 2023 View Map

View GroundRent Redemption

View GroundRent Registration

Special Tax Recapture: None

Account Identifier:

District - 13 Account Number - 019479

Owner Information

Owner Name:

REPC & HTC LLC

RESIDENTIAL

Mailing Address:

C/O ROBERT P CANNON

Principal Residence:

/02532/ 00020

106 W CIRCLE AVE

SALISBURY MD 21801-4944

Location & Structure Information

Premises Address: 226 NEWTON ST

SALISBURY 21801-0000

Legal Description:

Deed Reference:

9,000 SQFT

226 NEWTON ST

Grid:

Parcel: Neighborhood: 0263 13030702.23

Subdivision: 0000

Section: Block:

Lot:

Assessment Year: 2022

CITY OF SALIS Plat No:

Plat Ref:

0011 Town: SALISBURY

**Primary Structure Built** 1915

2,370 SF

Above Grade Living Area Finished Basement Area Property Land Area

County Use

Stories Basement Type

Exterior

Quality Full/Half Bath Garage Last Notice of Major Improvements

9,000 SF

2

Map:

0111

NO STANDARD UNIT

ASBESTOS SHINGLE/

2 full

#### Value Information

|                    | Base Value | Value            | Phase-in Assessm | ents             |
|--------------------|------------|------------------|------------------|------------------|
|                    |            | As of 01/01/2022 | As of 07/01/2022 | As of 07/01/2023 |
| Land:              | 9,000      | 8,600            |                  |                  |
| Improvements       | 7,500      | 300              |                  |                  |
| Total:             | 16,500     | 8,900            | 8,900            | 8,900            |
| Preferential Land: | 0          | 0                |                  |                  |

#### Transfer Information

Seller: CANNON, ROBERT P & HILDAT Type: NON-ARMS LENGTH OTHER

Date: 12/30/2005 Deed1: /02532/ 00020 Price: \$0 Deed2:

Seller:

Date:

Price:

Type:

Deed1:

Deed2: Price:

Seller: Type:

Date: Deed1:

Deed2:

### Exemption Information

Partial Exempt Assessments: County: State:

07/01/2022 0.00 0.00

0.00|0.00

07/01/2023

0.00|0.00

Municipal: Special Tax Recapture: None

Homestead Application Information

Homestead Application Status: No Application

Homeowners' Tax Credit Application Information

Homeowners' Tax Credit Application Status: No Application

Date:

# Salisbury Historic District Commission

# **Hearing Notification**

July 26, 2023

**Hearing Date:** 

| Time:                            | 7:00 pm  |
|----------------------------------|--|
| Location:                        | Government Office Building<br>125 N. Division Street<br>Salisbury, MD. 21804<br>Room 301 |
| Case Number:                     | #23-19   |
| <b>Commission Considering:</b>   | Alterations  |
| Owner's Name:                    | REPC LLC   |
| Applicant Name:                  | Robert Cannon  |
| Agent/Contractor:                | Not Indicated  |
| <b>Subject Property Address:</b> | 228 Newton St.   |
| Historic District:               | Camden Historic District   |
| Use Category:                    | Residential  |
| Chairman:                        | Mr. Scott Saxman   |
| HDC Staff contact:               | Jessica Budd<br>Associate Planner I<br>(410) 548-3170                                    |

# Salisbury Historic District Commission

125 N. Division Street Room 202 Salisbury, MD 21801 (410) 548-3170/ fax (410) 548-3107

Application Processor (Date)

Permit Application \$50 Fee Received 7/1/23 (date)


Secretary, S.H.D.C. (Date)


| E/E/00  |  |  |  |
|---|--|--|--|
| Date Submitted: 7/7/23  | Case #: # 23 - 19  |  |  |
| Date Accepted as Complete: 7/7/23   | Action Required By (45 days): 8/20/23  |  |  |
| Subject Location: 228 NEWTON STREET   | Owner Name: REPC LLC   |  |  |
| Application by: ROBERT CANNON   |  |  |  |
| Applicant Address: 106 CJRCLE AVE, SALISBURY, MD 21801  | Owner Address: <u>Ob Robert Canvon</u> , 106 CTRCL   |  |  |
| Applicant Phone: 410-749-5179   | Owner Phone: 410-749-5/79  |  |  |
|   | Owner Email: <u>CANNON &amp; COMCAST NET</u>   |  |  |
| Work Involves:New Constructi  | onAddition Other   |  |  |
| DemolitionSign  | Awning Estimated Cost 200,000  |  |  |
| <b>DESCRIPTION OF WORK PROPOSED</b> (Please be specific   | c. Attach sheet if space is inadequate) Type of  |  |  |
| material, color, dimensions, etc. must accompany applicatio   | n. If signs are proposed, indicate material  |  |  |
| method of attachment, position on building, size and front lir  | neal feet of building, size and position of all  |  |  |
| other signs on building, and a layout of the sign.  |  |  |  |
| Est Ambrild   |  |  |  |
| SEE A MACHER  |  |  |  |
|   |  |  |  |
|   |  |  |  |
| Do you intend to apply for Federal or State Rehabilitation Maryland Historical Trust staff?  Yes No  If you have checked "Yes" to either of the above question  Letter from the Maryland Historic Trust  See Reverse Side for DOCUMENTS REQUIRED  All required documents must be submitted to the City Planner, Deleast 30 days prior to the next public meeting. Failure to include a applicant or his/her authorized representative to appear at the schapplication until the next regular scheduled meeting. If an application resubmitted for one year from date of such action. Please be adviced Commission or staff, may visit the subject property prior to the schedule project. | ons, please provide a copy of your approval along with this application.  TO BE FILED WITH APPLICATION epartment of Infrastructure and Development at II the required attachments and/or failure of the neduled meeting may result in postponement of the tion is denied, the same application cannot be sed that members of the Salisbury Historic District |  |  |
| The Salisbury Historic District Commission Rules and Regulations the office of the Department of Infrastructure and Development fo website: www.ci.salisbury.md.us.   | s and Design Guidelines are available for review in<br>r the City of Salisbury as well as on the City's  |  |  |
| I, or my authorized representative, will appear at the meeting of thon(date).   | ne Salisbury Historic District Commission  |  |  |
| I hereby certify that the owner of the subject premises has been for that said owner is in full agreement with this proposal.  Applicant's  | -  |  |  |
| Signature   | Date 6-27-23   |  |  |
| An Bee 7/7/23   | Brian Soper 7/17/23  |  |  |


# 228 Newton Street


# Proposed renovation plans:


- 1. Install vinyl siding on the exterior of the house to match as close as possible the old clapboard and clamshell siding that is presently underneath the asbestos shingles;
- 2. Replace the windows with vinyl replacement windows with similar grills. It should be noted that some of the current windows are very large and dangerous in that the bottoms of the windows are only 19 inches above the floor. We intend to replace them with windows that meet the current code compliant size and height requirements;
- 3. Wrap the exterior widow trim and boxing in metal;
- 4. Replace roofs with architectural asphalt shingles;
- 5. Install gable vents for proper ventilation of the attic in place of the gable windows;
- 6. Install new exterior metal doors; and
- 7. Install a new front porch deck with similar tongue and groove vinyl decking boards and replace the posts and bannisters with similar size and shape plastic or vinyl.

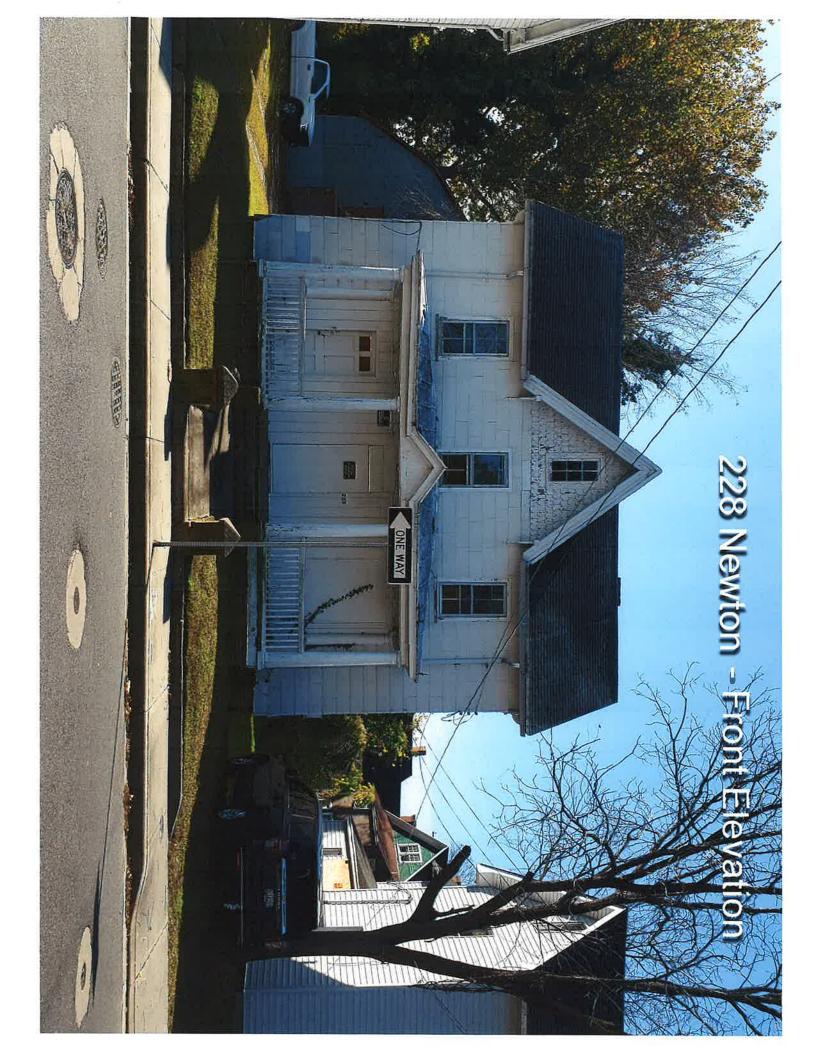


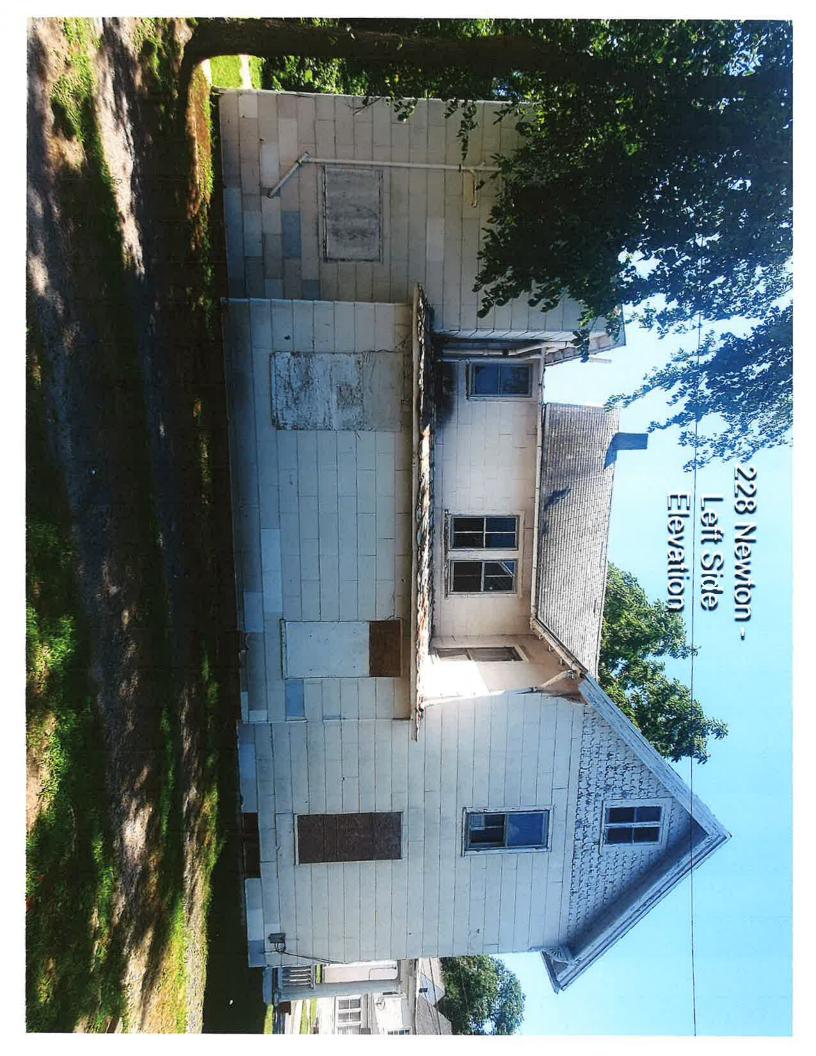


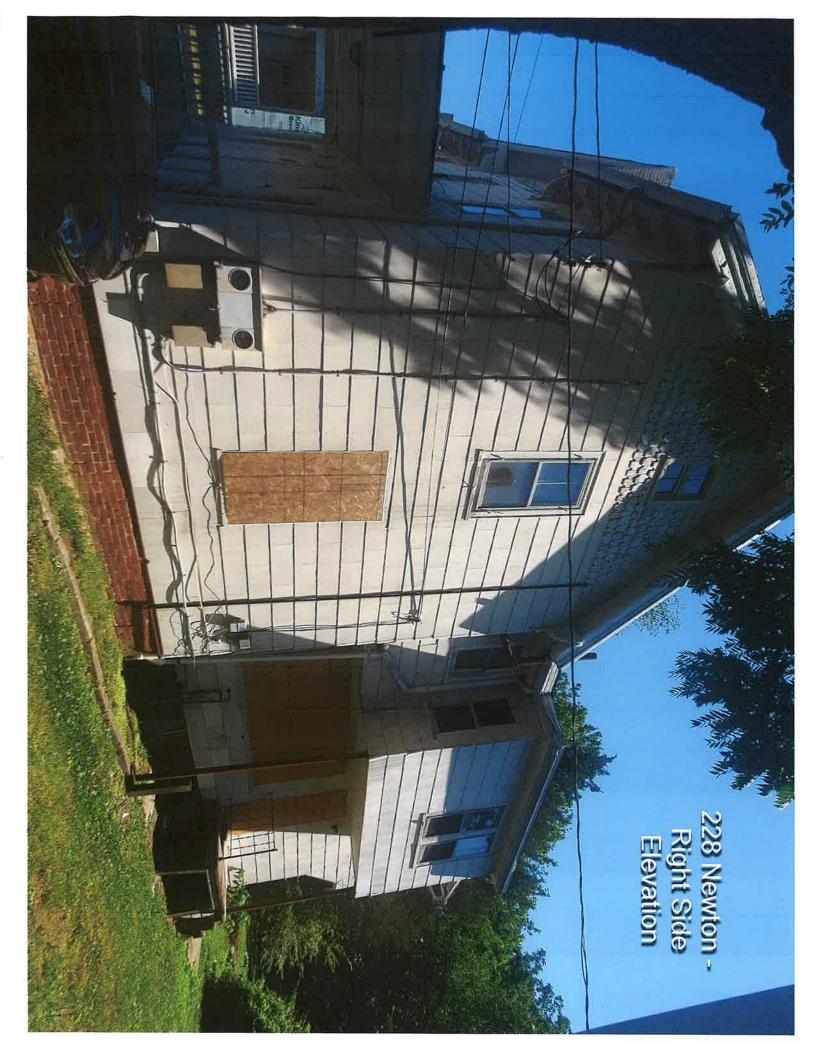


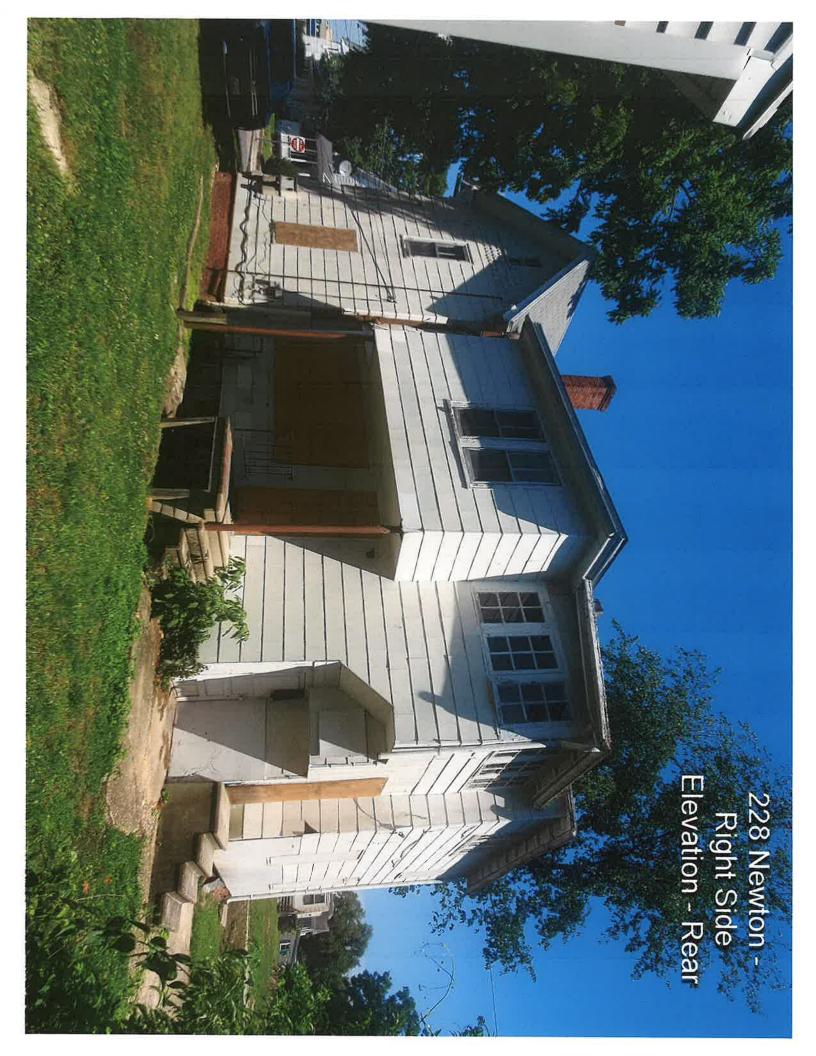


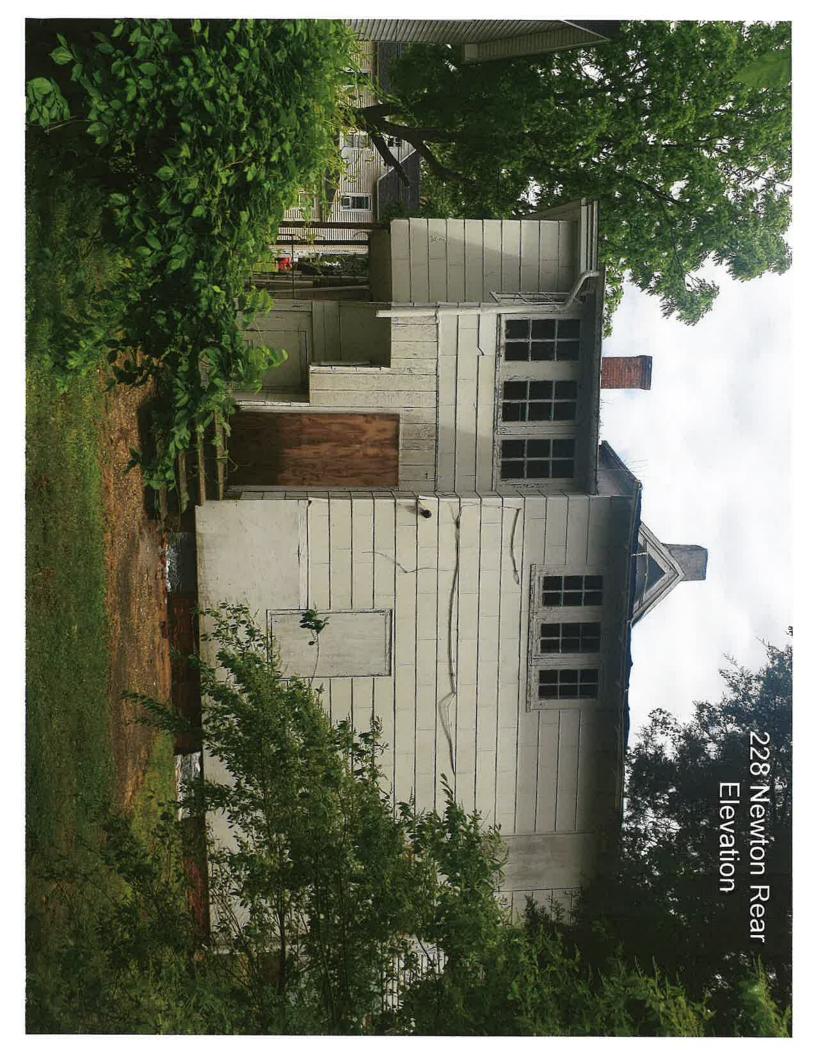


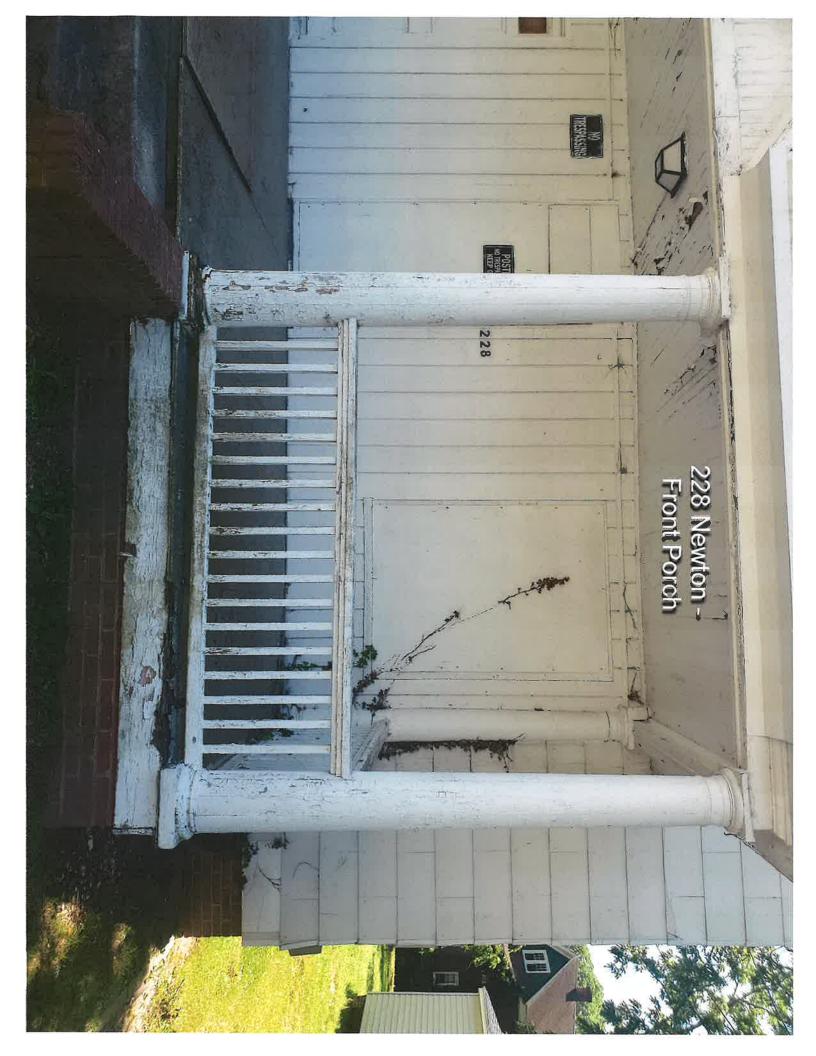

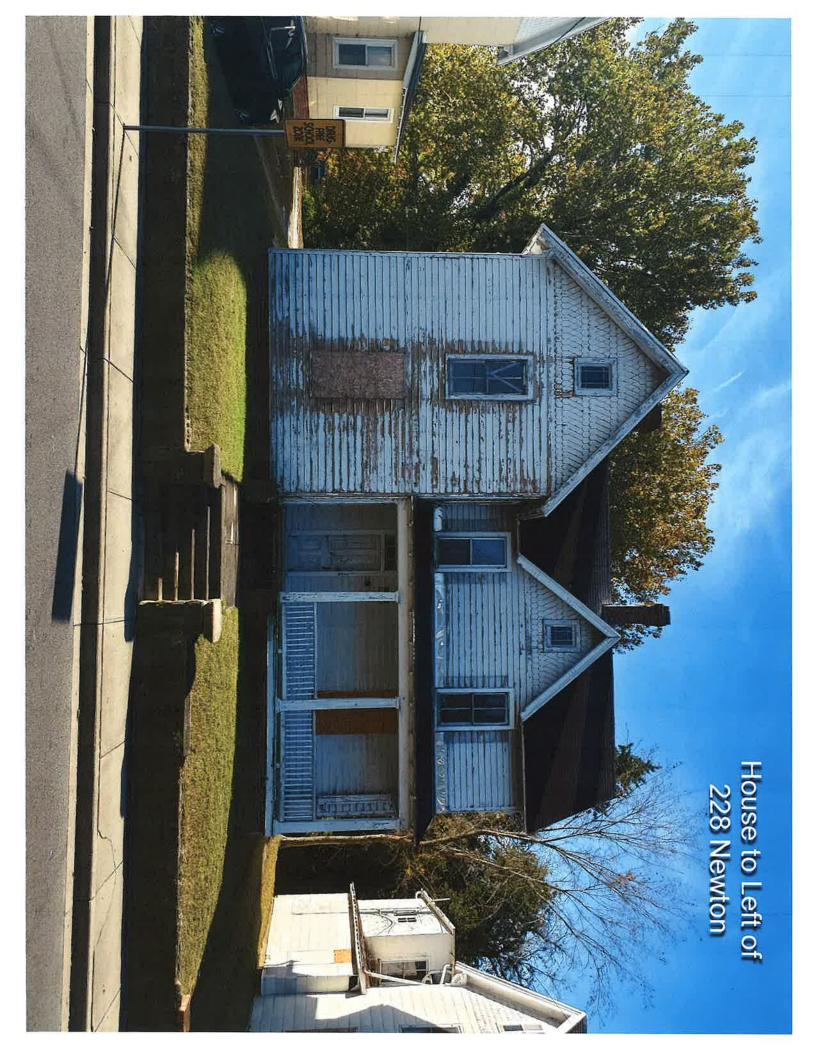

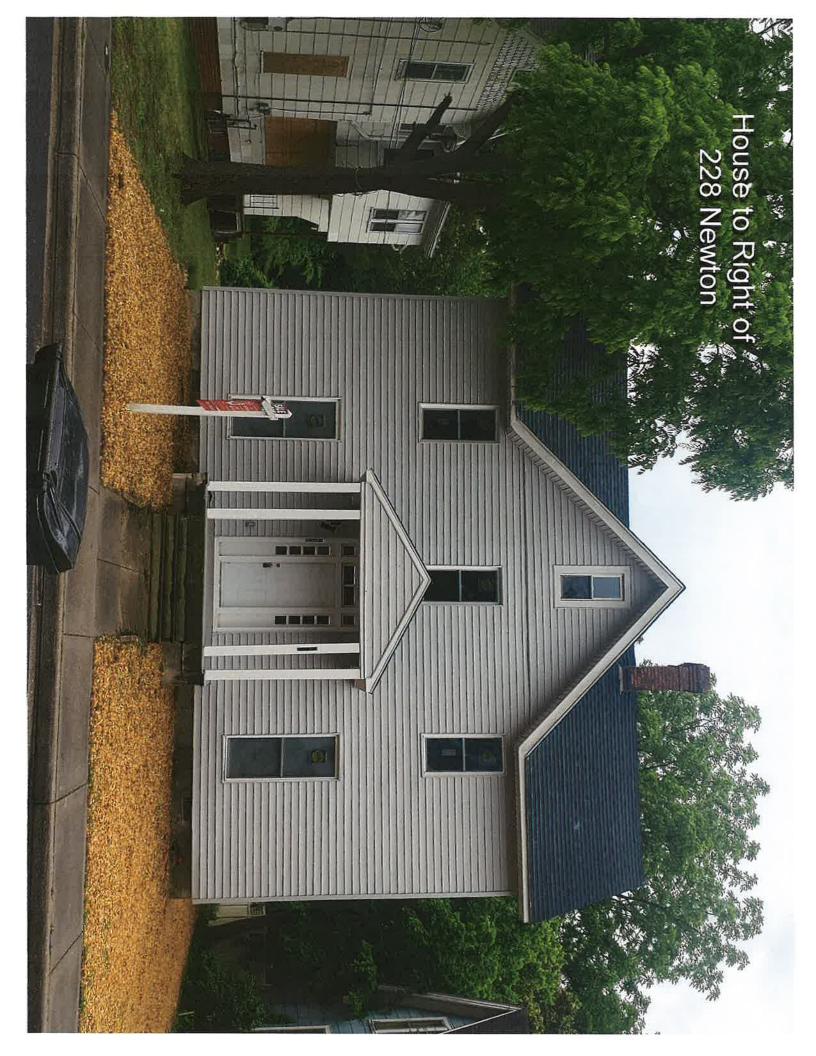

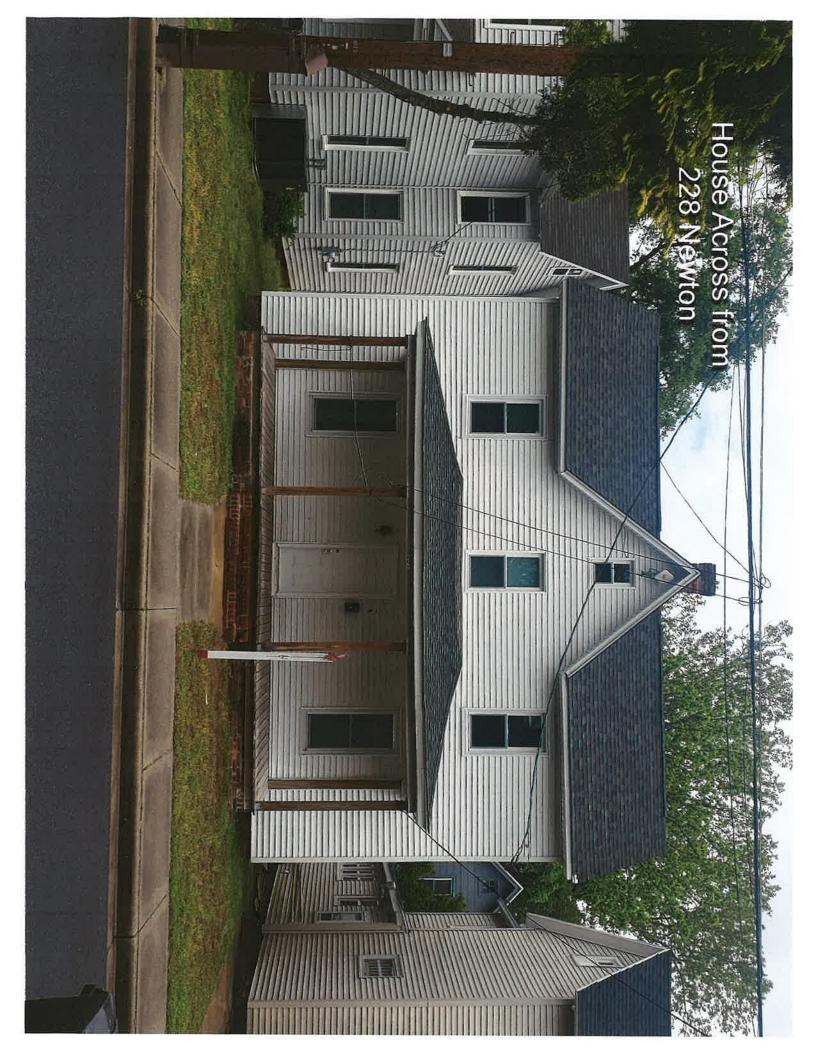

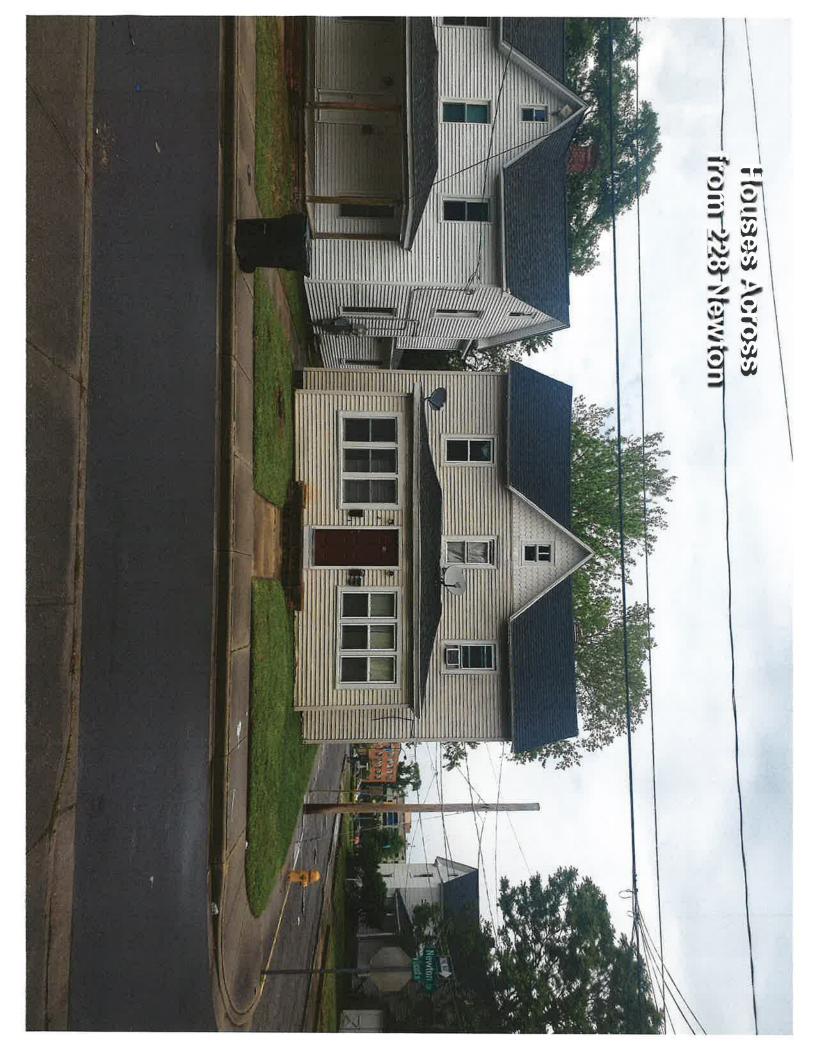

# Moth 2 lik wobaiw Toof



# Viwinco Dealer Quote

# BEACON BUILDING PRODUCTS **505 MARVEL RD** SALISBURY, MD 21801

|   | Quote Number:           |  |
|---|-------------------------|--|
|   | 00315013                |  |
|   | Job Name:               |  |
|   | Will Chavez             |  |
| ( | Quote Date: May 9, 2022 |  |
|   |                         |  |

Sold To: 50158620

505 Marvel Road Salisbury, MD 21801 Ship To:

505 Marvel Road Salisbury, MD 21801

| Line# | Qty<br>Ordered | Order Specifications |
|-------|----------------|----------------------|
| 0001  | 6              | S-Series Double Hung |

APPLICATION: NEW CONSTRUCTION (NON-IMPACT)

MEASURE CODE: ROUGH OPENING

WIDTH: 28.7500 **HEIGHT:** 67.0000 LAYOUT: EQUAL LITE

**COLOR:** WHITE EXTERIOR / WHITE INTERIOR GLASS PACKAGE: STANDARD GLASS PACKAGE GLASS COLOR OPTIONS: CLEAR / LOW-E

**GRID TYPE: NONE** 

SCREEN: EXTRUDED HALF SCREEN

SCREEN MESH: BVUE\_V SCREEN SHIP: IN WINDOW

LOCK AND KEEPER FINISH: WHITE FINISH

HARDWARE: THIS WINDOW DOES NOT MEET EGRESS

Performance: SHGC: 0.20, U-Factor: 0.29, VT: 0.46, CPD: VWN-K-10-00638-00001

DP Value: 50


Florida Approval: 17528.1

Date Printed: 5/16/2023 02:06 PM Created By: davidm@roofcenter.com Page 1 of 4 00315013

Oty Line# Ordered **Order Specifications** 0002

**S-Series Double Hung** 

Viewed from Exterior

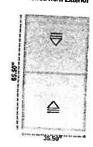

APPLICATION: NEW CONSTRUCTION (NON-IMPACT)

MEASURE CODE: ROUGH OPENING

WIDTH: 36.0000 HEIGHT: 66.0000 LAYOUT: EQUAL LITE

COLOR: WHITE EXTERIOR / WHITE INTERIOR GLASS PACKAGE: STANDARD GLASS PACKAGE

GLASS COLOR OPTIONS: CLEAR / LOW-E

GRID TYPE: NONE

SCREEN: EXTRUDED HALF SCREEN

SCREEN MESH: BVUE V SCREEN SHIP: IN WINDOW

LOCK AND KEEPER FINISH: WHITE FINISH


HARDWARE: THIS WINDOW MEETS EGRESS, EGRESS HARDWARE IS INSTALLED

Performance: SHGC: 0.20, U-Factor: 0.29, VT: 0.46, CPD: VWN-K-10-00638-00001

Florida Approval: 17528.1

0003 6 S-Series Double Hung

Viewed from Exterior

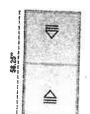

APPLICATION: NEW CONSTRUCTION (NON-IMPACT)

MEASURE CODE: ROUGH OPENING

WIDTH: 28.7500 HEIGHT: 56,7500 LAYOUT: EQUAL LITE

COLOR: WHITE EXTERIOR / WHITE INTERIOR GLASS PACKAGE: STANDARD GLASS PACKAGE GLASS COLOR OPTIONS: CLEAR / LOW-E

GRID TYPE: NONE

SCREEN: EXTRUDED HALF SCREEN

SCREEN MESH: BVUE\_V SCREEN SHIP: IN WINDOW

LOCK AND KEEPER FINISH: WHITE FINISH

HARDWARE: THIS WINDOW DOES NOT MEET EGRESS

Performance: SHGC: 0.20. U-Factor: 0.29, VT: 0.46, CPD: VWN-K-10-00638-00001

Florida Approval: 17528.1

Date Printed: 5/16/2023 02:06 PM Created By: davidm@roofcenter.com Page 2 of 4 00315013

Otv Line# **Ordered Order Specifications** 0004

**S-Series Double Hung** 

Viewed from Exterior

27.00"

APPLICATION: NEW CONSTRUCTION (NON-IMPACT)

MEASURE CODE: ROUGH OPENING

WIDTH: 27.5000 **HEIGHT: 37.5000** LAYOUT: EQUAL LITE

COLOR: WHITE EXTERIOR / WHITE INTERIOR GLASS PACKAGE: STANDARD GLASS PACKAGE

GLASS COLOR OPTIONS: CLEAR / LOW-E

GRID TYPE: NONE

SCREEN: EXTRUDED HALF SCREEN

SCREEN MESH: BVUE V SCREEN SHIP: IN WINDOW

LOCK AND KEEPER FINISH: WHITE FINISH

HARDWARE: THIS WINDOW DOES NOT MEET EGRESS

Performance: SHGC: 0.20, U-Factor: 0.29, VT: 0.46, CPD: VWN-K-10-00638-00001

Florida Approval: 17528.1

0005

**S-Series Double Hung** 

44.75

1

APPLICATION: NEW CONSTRUCTION (NON-IMPACT)

MEASURE CODE: ROUGH OPENING

WIDTH: 42.2500 HEIGHT: 58.7500 LAYOUT: EQUAL LITE

COLOR: WHITE EXTERIOR / WHITE INTERIOR GLASS PACKAGE: STANDARD GLASS PACKAGE GLASS COLOR OPTIONS: CLEAR / LOW-E

GRID TYPE: NONE

SCREEN: EXTRUDED HALF SCREEN

SCREEN MESH: BVUE\_V **SCREEN SHIP: IN WINDOW** 

LOCK AND KEEPER FINISH: WHITE FINISH

HARDWARE: DOUBLE LOCKS / THIS WINDOW MEETS EGRESS, EGRESS HARDWARE

Performance: SHGC: 0.20. U-Factor: 0.29, VT: 0.46, CPD: VWN-K-10-00638-00001 DP Value: 50

Florida Approval: 17528.1 S-Series Mulled Units 3U-1R3C

0006

CONFIG: 3U-1R3C APPLICATION: NEW CONSTRUCTION (NON-IMPACT)

MEASURE CODE: ROUGH OPENING

OVERALL WIDTH: 63.0000 **OVERALL HEIGHT: 36.5000** 

**CUSTOM SIZES: NO** 

COLOR: WHITE EXTERIOR / WHITE INTERIOR GLASS PACKAGE: STANDARD GLASS PACKAGE

**UNIT 01: S-Series Double Hung** 

WIDTH: 20,5000 HEIGHT: 36,0000

Date Printed: 5/16/2023 02:06 PM Created By: davidm@roofcenter.com Page 3 of 4

50 50

26.60

00315013

Qty Line# Ordered **Order Specifications** LAYOUT: EOUAL LITE COLOR: WHITE EXTERIOR / WHITE INTERIOR GLASS PACKAGE: STANDARD GLASS PACKAGE GLASS COLOR OPTIONS: CLEAR / LOW-E **GRID TYPE: NONE** SCREEN: EXTRUDED HALF SCREEN SCREEN MESH: BVUE V SCREEN SHIP: IN WINDOW LOCK AND KEEPER FINISH: WHITE FINISH HARDWARE: THIS WINDOW DOES NOT MEET EGRESS **UNIT 02: S-Series Double Hung** WIDTH: 20.5000 HEIGHT: 36.0000 LAYOUT: EQUAL LITE COLOR: WHITE EXTERIOR / WHITE INTERIOR GLASS PACKAGE: STANDARD GLASS PACKAGE GLASS COLOR OPTIONS: CLEAR / LOW-E **GRID TYPE:** NONE SCREEN: EXTRUDED HALF SCREEN SCREEN MESH: BVUE V SCREEN SHIP: IN WINDOW LOCK AND KEEPER FINISH: WHITE FINISH HARDWARE: THIS WINDOW DOES NOT MEET EGRESS **UNIT 03: S-Series Double Hung** WIDTH: 20.5000 **HEIGHT: 36.0000** LAYOUT: EQUAL LITE **COLOR:** WHITE EXTERIOR / WHITE INTERIOR GLASS PACKAGE: STANDARD GLASS PACKAGE GLASS COLOR OPTIONS: CLEAR / LOW-E **GRID TYPE: NONE** SCREEN: EXTRUDED HALF SCREEN **SCREEN MESH: BVUE V** SCREEN SHIP: IN WINDOW LOCK AND KEEPER FINISH: WHITE FINISH HARDWARE: THIS WINDOW DOES NOT MEET EGRESS Performance (All Units): SHGC: 0.20, U-Factor: 0.29, VT: 0.46, CPD: VWN-K-10-00638-00001 DP Value: 50 Florida Approval (All Units): 17528.1 Date Printed: 5/16/2023 02:06 PM Created By: davidm@roofcenter.com Page 4 of 4 **QUOTE DISCLAIMER** We ask that you thoroughly review the quote for accuracy, before ordering the product. By responding to this email, or signing the quote, you authorize us to order the product/special order product and you agree all quantities, sizes, and specifications are correct. No changes or cancellations can occur once special order items have been submitted to the manufacturer. THIS ESTIMATE IS VALID FOR 30 DAYS. SPECIAL ORDER ITEMS CANNOT BE RETURNED.

Date: \_

Customer Signature: \_

# Salisbury Historic District Commission

# **STAFF FINDINGS**

# Meeting of July 26, 2023

**Case Number:** #23-19 **Commission Considering:** Alterations **Owner Name:** REPC LLC **Owners Address:** 106 Circle Ave Salisbury, MD 21801 **Applicant Name:** Robert Cannon 106 Circle Ave **Applicant's Address:** Salisbury, MD 21801 **Agent/Contractor: TBD Subject Property Address:** 228 Newton St **Historic District:** Camden Historic District Residential **Use Category: Zoning Classification:** R-8**Structure / Site Description: Built Date:** 1910 **Enclosed Area:** 2,640 sq. ft. **Lot Size:** 7,500 sq. ft.

2

**TBD** 

**Number of Stories:** 

**Contributing Structure:** 

**Wicomico County Historic Survey on file:** No

**Nearby Properties on County Survey:** Yes

# **Including but not limited to:**

232 Newton St- William Mitchell House

**Explanation of Request:** The applicant is seeking approval to repair the following:

- Install Vinyl Siding
- Replace windows with vinyl, and wrap window trim
- Replace the roof with architectural asphalt shingles
- Install gable vents for proper ventilation of the attic in place of gable windows
- Install new exterior metal doors
- Install new front porch deck. With similar tongue and groove vinyl decking boards and replace post and banisters with similar size and shape plastic or vinyl

## Areas of Historic Guidelines to be considered:

## Guideline 13: Match Existing or Historic Siding

- a. Where full-scale siding replacement is necessary, match the historic or existing siding on the building. Keep the details (width of wood boards, shingle size, corner and seam details, etc.) consistent with the historic appearance.
- b. When replacing non-historic siding that was inappropriately applied, chose an appropriate replacement that is consistent with buildings of the type, period, and architectural style.
- c. Do not cover historically uncovered masonry surfaces with siding. Siding applied to masonry surfaces has the potential to hold moisture and cause damage to the underlying wall.

### Guideline 14: Synthetic Siding

Synthetic siding describes a siding product not made from natural materials. Vinyl, asphalt, and fiber cement board are the most commonly found synthetic siding types.

- a. The use of new synthetic siding may be approved on a case by case basis if one or more of the following conditions are met.
- b. Historic decorative details should not be removed or covered by synthetic siding. These details include but are not limited to cornices, window hoods, moldings, eaves, decorative shingles, and trim.
- c. Synthetic siding may not be applied over historically uncovered masonry walls.

# **Guideline 17:** Retain Historic Windows

a. Maintain or restore the historic shape, size, alignment, pattern, and details of existing historic windows, particularly those in upper stories of commercial properties. (For guidelines on storefront windows, see the Storefronts Guidelines in the following section).

- b. Do not infill window openings or cover existing historic windows.
- c. Consider reopening windows that are presently blocked, if your budget allows.

# Guideline 18: New Window Openings and Infill

Altering window openings in historic facades alters the building's historic appearance significantly, and is typically not appropriate, but may be considered in some situations.

- a. Avoid placing new openings on the front facade.
- b. If new openings are required for additional light, consider placing them on the rear or side elevations of the building or installing a skylight on a non-visible roof slope.
- c. Avoid infilling existing window openings on the front facade.
- d. Where recent changes have altered historic window openings, restoration of the historic configuration and materials is encouraged.

# **Guideline 24:** Roofing Material

In-kind replacement of roofing materials is always preferable to replacement with a new material, however, this is not always feasible. Standing seam metal in copper, tin, or terne coated steel are traditional materials which can be replaced with new versions provided that they are flat and of a uniform color and texture. Asphalt, asphalt shingles, and mineral fiber slate may be appropriate substitutes for many traditional materials.

- a. Retain and repair the historic roof material when feasible.
- b. Where replacement is necessary, match the historic materials as closely as possible in terms of material, size, color, and pattern.
- c. Requests for substitute roofing materials will be reviewed on a case-by-case basis.
- d. When asphalt shingles are used to replace wood or slate, heavy weight architectural shingles which provide depth and variation, and which match the shape of the historic materials, are preferred.
- e. Roofing materials on additions should match or mimic the material on the main body of the historic building.
- f. Roofing materials on new construction should be consistent with the prevalent roofing material on surrounding buildings.
- g. Repair of isolated sections of a roof must match the existing tiles in material composition, style, size and color.

## **Guideline 28:** Chimneys and Vents

- a. Maintain existing chimneys. When repairs are necessary, match the existing materials, colors, shape, brick pattern, and details as closely as possible.
- b. Avoid changing the height, massing, or scale of existing chimneys.
- c. New vents should be placed in a location which is not visible from the public right of way.
- d. New chimneys on new construction should be consistent with the height, massing, and proportions of chimneys found in the surrounding area.

## **Guideline 53:** Replacing Residential Doors

- a. Where replacement is necessary, the new door should match the historic door in placement, size, type, and configuration wherever possible.
- b. When restoring missing historic doors, use pictorial evidence to produce the replacements, if your budget allows. A salvaged replacement in the same style that fits the opening, or a new door in a complimentary style are also appropriate choices.
- c. If replacement with a new door is unavoidable, chose one that mimics the size, scale, design,

and texture of an appropriate historic door. Proportions and details should be in keeping with the building's architectural style.

d. Maintain the historic door opening size and surrounding trim, including side lights and transoms. Do not alter the size of the opening to fit a smaller or larger door, unless required by code.

## **Guideline 55:** Restore Historic Porch Features

- a. Maintain the historic porch or stoop when feasible. Keep wooden surfaces painted and keep up with general maintenance.
- b. If repair or rehabilitation is necessary, keep as much of the historic materials in place as possible. Maintain the porch's design, proportion, and ornament to the greatest extent
- c. Replace missing porch posts and railings where necessary. Match the size, shape, profile, proportion, and spacing to the original features.
- d. Use of synthetic replacement materials may be allowed if the new material closely approximates the size, scale, texture, and overall appearance of the historic feature.

## **Guideline 56:** Replacement Porches

- a. If porch replacement is necessary in whole or in part, reconstruct it to match the historic porch in size, scale, and overall design. Where possible, detail and ornamentation should be replicated.
- b. Use the same or similar materials wherever feasible.
- c. Avoid applying decorative elements that are not appropriate to the style of the dwelling. Whenever possible, choose accurate details based on historic photographs or similar properties of the same period and style.

# **Evaluation Criteria:**

Pursuant to Section 17.52.040 A & B of the Salisbury Zoning Code, it is the duty of the Historic District Commission to review all applications to construct, alter, reconstruct, move or demolish any structure within a Historic District whenever the exterior appearance of such structure is affected, and to approve or reject said application. In reviewing an application and plans, the Commission should give consideration to review criteria, and may make a determination as to which of said Criteria are applicable.

> Staff Findings Prepared By: Jessica Budd Infrastructure and Development 125 N Division Street, Suite 202 Salisbury, MD 21801 (410) 548-3170

Date: July 17, 2023

View Map

View GroundRent Redemption

View GroundRent Registration

Special Tax Recapture: None

Account Identifier:

District - 13 Account Number - 019479

Owner Information

Owner Name:

REPC & HTC LLC

RESIDENTIAL

Mailing Address:

C/O ROBERT P CANNON

Principal Residence:

/02532/ 00020

106 W CIRCLE AVE

SALISBURY MD 21801-4944

Location & Structure Information

Premises Address: 226 NEWTON ST

SALISBURY 21801-0000

Legal Description:

Deed Reference:

9,000 SQFT

226 NEWTON ST

Grid:

Parcel: Neighborhood: 0263 13030702.23

Subdivision: 0000

Section: Block:

Lot:

Assessment Year: 2022

CITY OF SALIS Plat No:

Plat Ref:

0011 Town: SALISBURY

**Primary Structure Built** 1915

2,370 SF

Above Grade Living Area Finished Basement Area Property Land Area 9,000 SF

County Use

Stories Basement Type

Exterior

2

Map:

0111

NO

STANDARD UNIT

ASBESTOS SHINGLE/

2 full

Quality Full/Half Bath Garage Last Notice of Major Improvements

#### Value Information

|                    | Base Value | Value            | Phase-in Assessm | ents             |
|--------------------|------------|------------------|------------------|------------------|
|                    |            | As of 01/01/2022 | As of 07/01/2022 | As of 07/01/2023 |
| Land:              | 9,000      | 8,600            |                  |                  |
| Improvements       | 7,500      | 300              |                  |                  |
| Total:             | 16,500     | 8,900            | 8,900            | 8,900            |
| Preferential Land: | 0          | 0                |                  |                  |

#### Transfer Information

Seller: CANNON, ROBERT P & HILDAT Type: NON-ARMS LENGTH OTHER

Date: 12/30/2005 Deed1: /02532/ 00020 Price: \$0 Deed2:

Seller:

Date:

Price:

Type:

Deed1:

Deed2:

Seller: Type:

Date: Deed1: Price: Deed2:

#### Exemption Information

Partial Exempt Assessments: Class 07/01/2022 07/01/2023 County: 000 0.00 State: 000 0.00 Municipal: 000 0.00|0.00 0.00|0.00

Special Tax Recapture: None

#### Homestead Application Information

Homestead Application Status: No Application

#### Homeowners' Tax Credit Application Information

Homeowners' Tax Credit Application Status: No Application

Date: